
WILMINGTON SUNSET PARK 115kV SUBSTATION

	SITE DATA TABLE				
PROJECT NAME:	WILMINGTON SUNSET PARK 115kV SUBSTATION				
PHYSICAL ADDRESS:	317 BORDEAUX AVENUE WILMINGTON, NC 28401				
OWNER/DEVELOPER:	DUKE ENERGY PROGRESS 410 S. WILMINGTON ST. RALEIGH, NC 27601 (919) 546-6123				
PARCEL ID NUMBER:	PIN NUMBER: 06013-021-004-000				
TOTAL PARCEL & IMPERVIOUS AREA:	4.53 AC (3.57 AC DISTURBED) EXISTING SITE IMPERVIOUS AREA: 3,423 SF/0.08 AC (1.8% PARCEL AREA) PROPOSED SITE IMPERVIOUS AREA: 9,160 SF/0.21 AC (4.6% PARCEL AREA) NET IMPERVIOUS AREA INCREASE: 5,737 SF/0.13 AC (2.8% PARCEL AREA)				
PROPOSED HEIGHT:	10'				
EXISTING BUILDING SQUARE FOOTAGE:	0				
PROPOSED BUILDING SQUARE FOOTAGE:	432 SF NONE				
REQUIRED PARKING:					
WETLANDS:	N/A				
ZONING:	O&I-1				
WATERSHED:	GREENFIELD LAKE - C;SW (CAPE FEAR RIVER BASIN)				
CAMA LAND USE:	URBAN				
FLOOD ZONE:	ZONE X PER FEMA MAP # 3720312600J REVISION 4/3/06				
SURVEYOR:	ESP ASSOCIATES P.A. 211 RACINE DRIVE, SUITE 101 WILMINGTON, NORTH CAROLINA 28403 (910) 313—6648				
ENGINEER:	MCADAMS 2905 MERIDIAN PKWY DURHAM, NC 27713 (919) 361-5000				
SETBACKS REQUIRED PROPOSED	FRONT: 20' SIDE: 20' REAR: 20' FRONT: 20' SIDE: 20'				

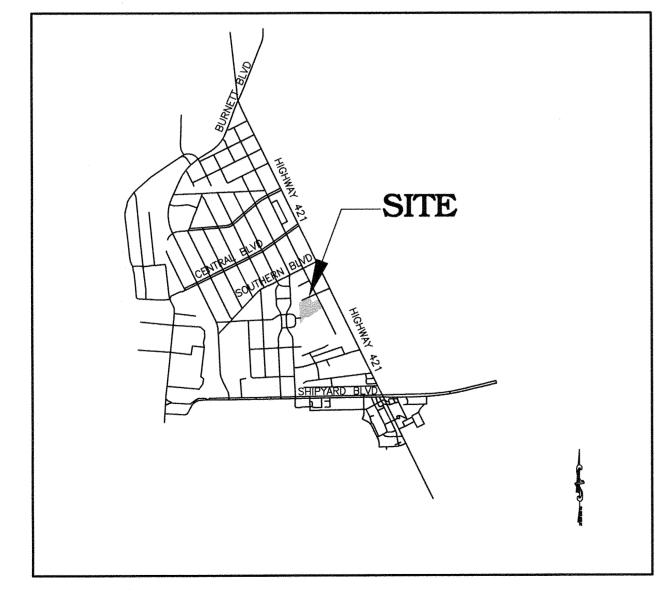

VICINITY MAP

NTS

CONSTRUCTION DRAWINGS

NEW HANOVER COUNTY, NORTH CAROLINA PROJECT NUMBER: DKE-17010


DATE: MAY 15, 2017 REVISED: JULY 14, 2017 REVISED: AUGUST 9, 2017 REVISED: SEPTEMBER 15, 2017

> LATITUDE: 34.1983 LONGITUDE: -77.9392 DUKE PROJECT NUMBER: 140606H03

OWNER:

DUKE ENERGY PROGRESS
410 S. WILMINGTON STREET
RALEIGH, NC 27601
CONTACT: PETER SOKALSKI

EMAIL: PETER.SOKALSKI@DUKE-ENERGY.COM PHONE: (919) 546-6123

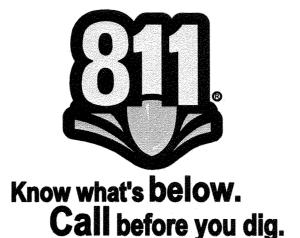


CONTRACTOR SHALL NOTIFY "NC811" (811) OR (1-800-632-4949) AT LEAST 3 FULL BUSINESS DAYS PRIOR TO BEGINNING CONSTRUCTION OR EXCAVATION TO HAVE EXISTING UTILITIES LOCATED. CONTRACTOR SHALL CONTACT ANY LOCAL UTILITIES THAT PROVIDE THEIR OWN LOCATOR SERVICES INDEPENDENT OF "NC811". REPORT ANY DISCREPANCIES TO THE ENGINEER IMMEDIATELY.

SHEET INDEX

- 1 COVER SHEET
 2 EXISTING CONDITIONS
- 3 TREE SURVEY
 4 PROJECT NOTES
- 5 DEMOLITION PLAN
- 6 SITE PLAN
- 7 GRADING AND STORM DRAINAGE PLAN
- 8 SEDIMENT & EROSION CONTROL STAGE 1
 9 SEDIMENT & EROSION CONTROL STAGE 2
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- 11 SEDIMENT & EROSION CONTROL DETAILS
- 12 SEDIMENT & EROSION CONTROL DETAILS
- 13 LANDSCAPE PLAN
- 14 ACCESS ROAD A & B PROFILES
- 15 NORTH SOUTH BASELINE PROFILE
- 16 EAST WEST BASELINE PROFILE
- 17 PROJECT DETAILS
- 18 PROJECT DETAILS AND TREE CONSERVATION DATA

	Approved Construction Plan
	Name. <u>Date</u>
Planning	
Traffic _	
Fire	

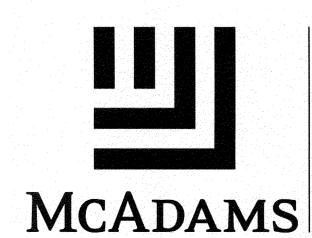



SHEET 1 OF 18 E JOHN R. McADA

THE JOHN R. McADAMS COMPANY, INC.

2905 Meridian Parkway
Durham, North Carolina 27713
License No.: C-0293
(800) 733-5646 • McAdamsCo.com
Contact: Daryl Riggins
Riggins@mcadamsco.com

FINAL DRAWING - NOT RELEASED FOR CONSTRUCTION

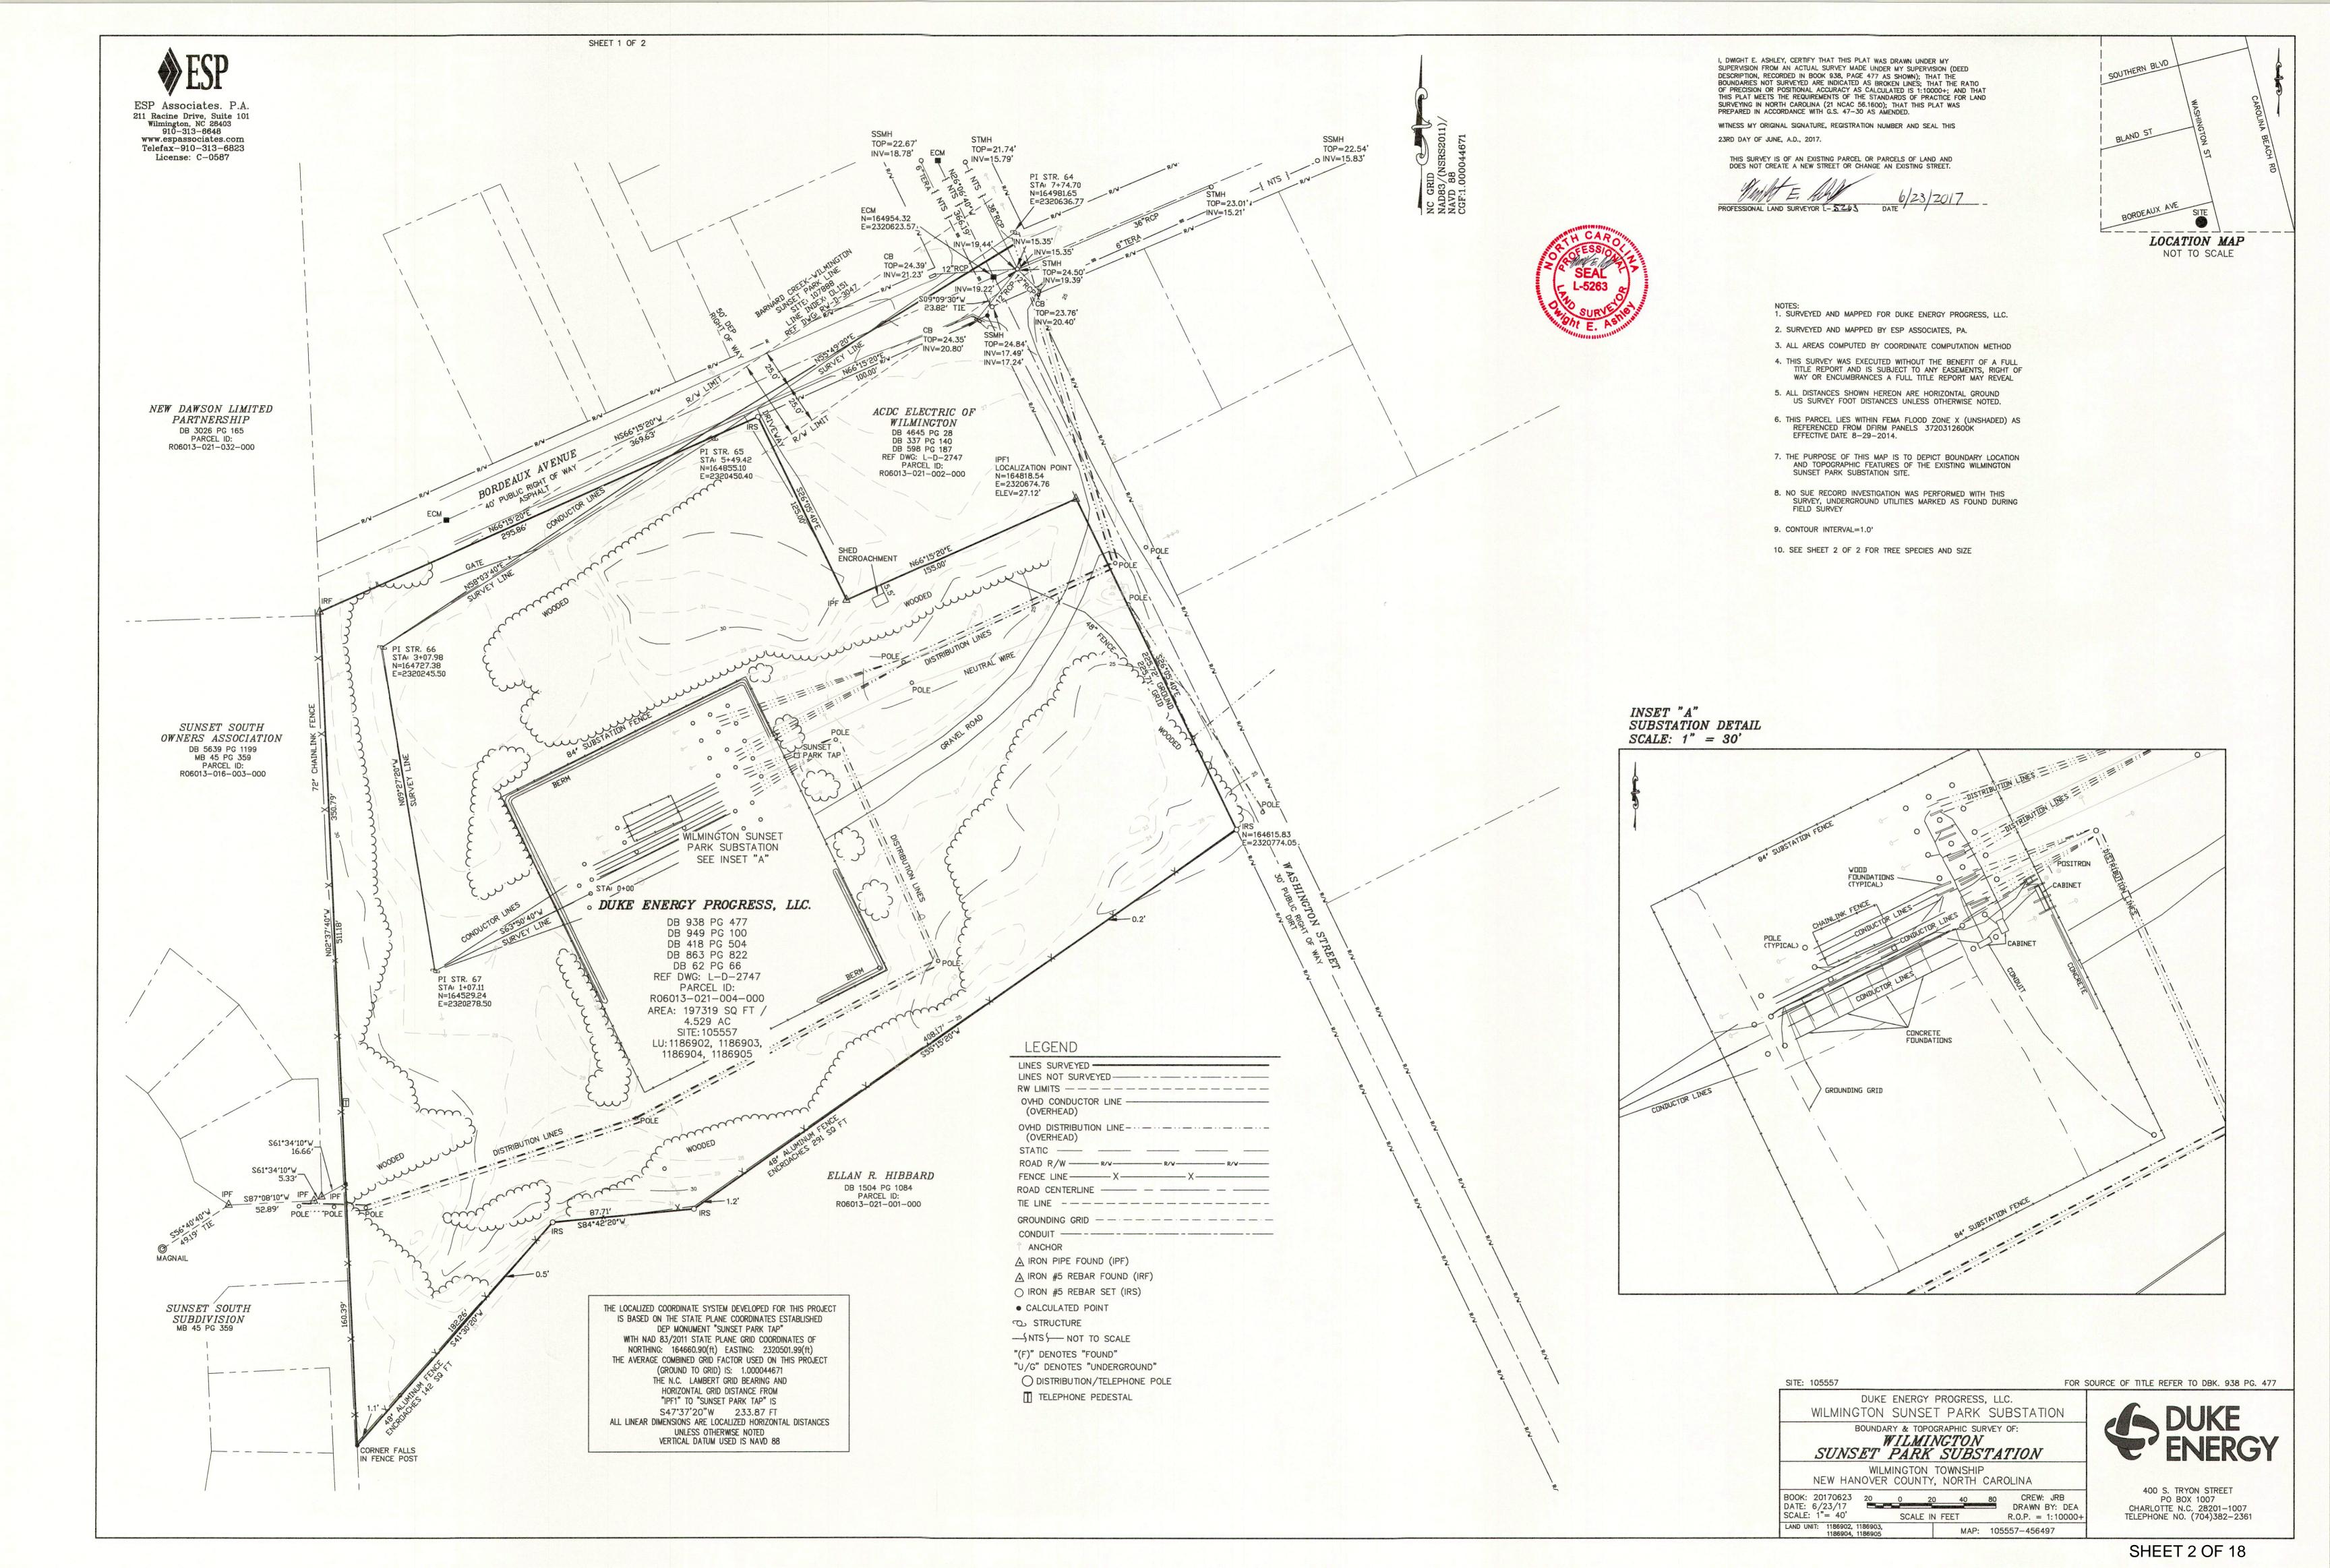

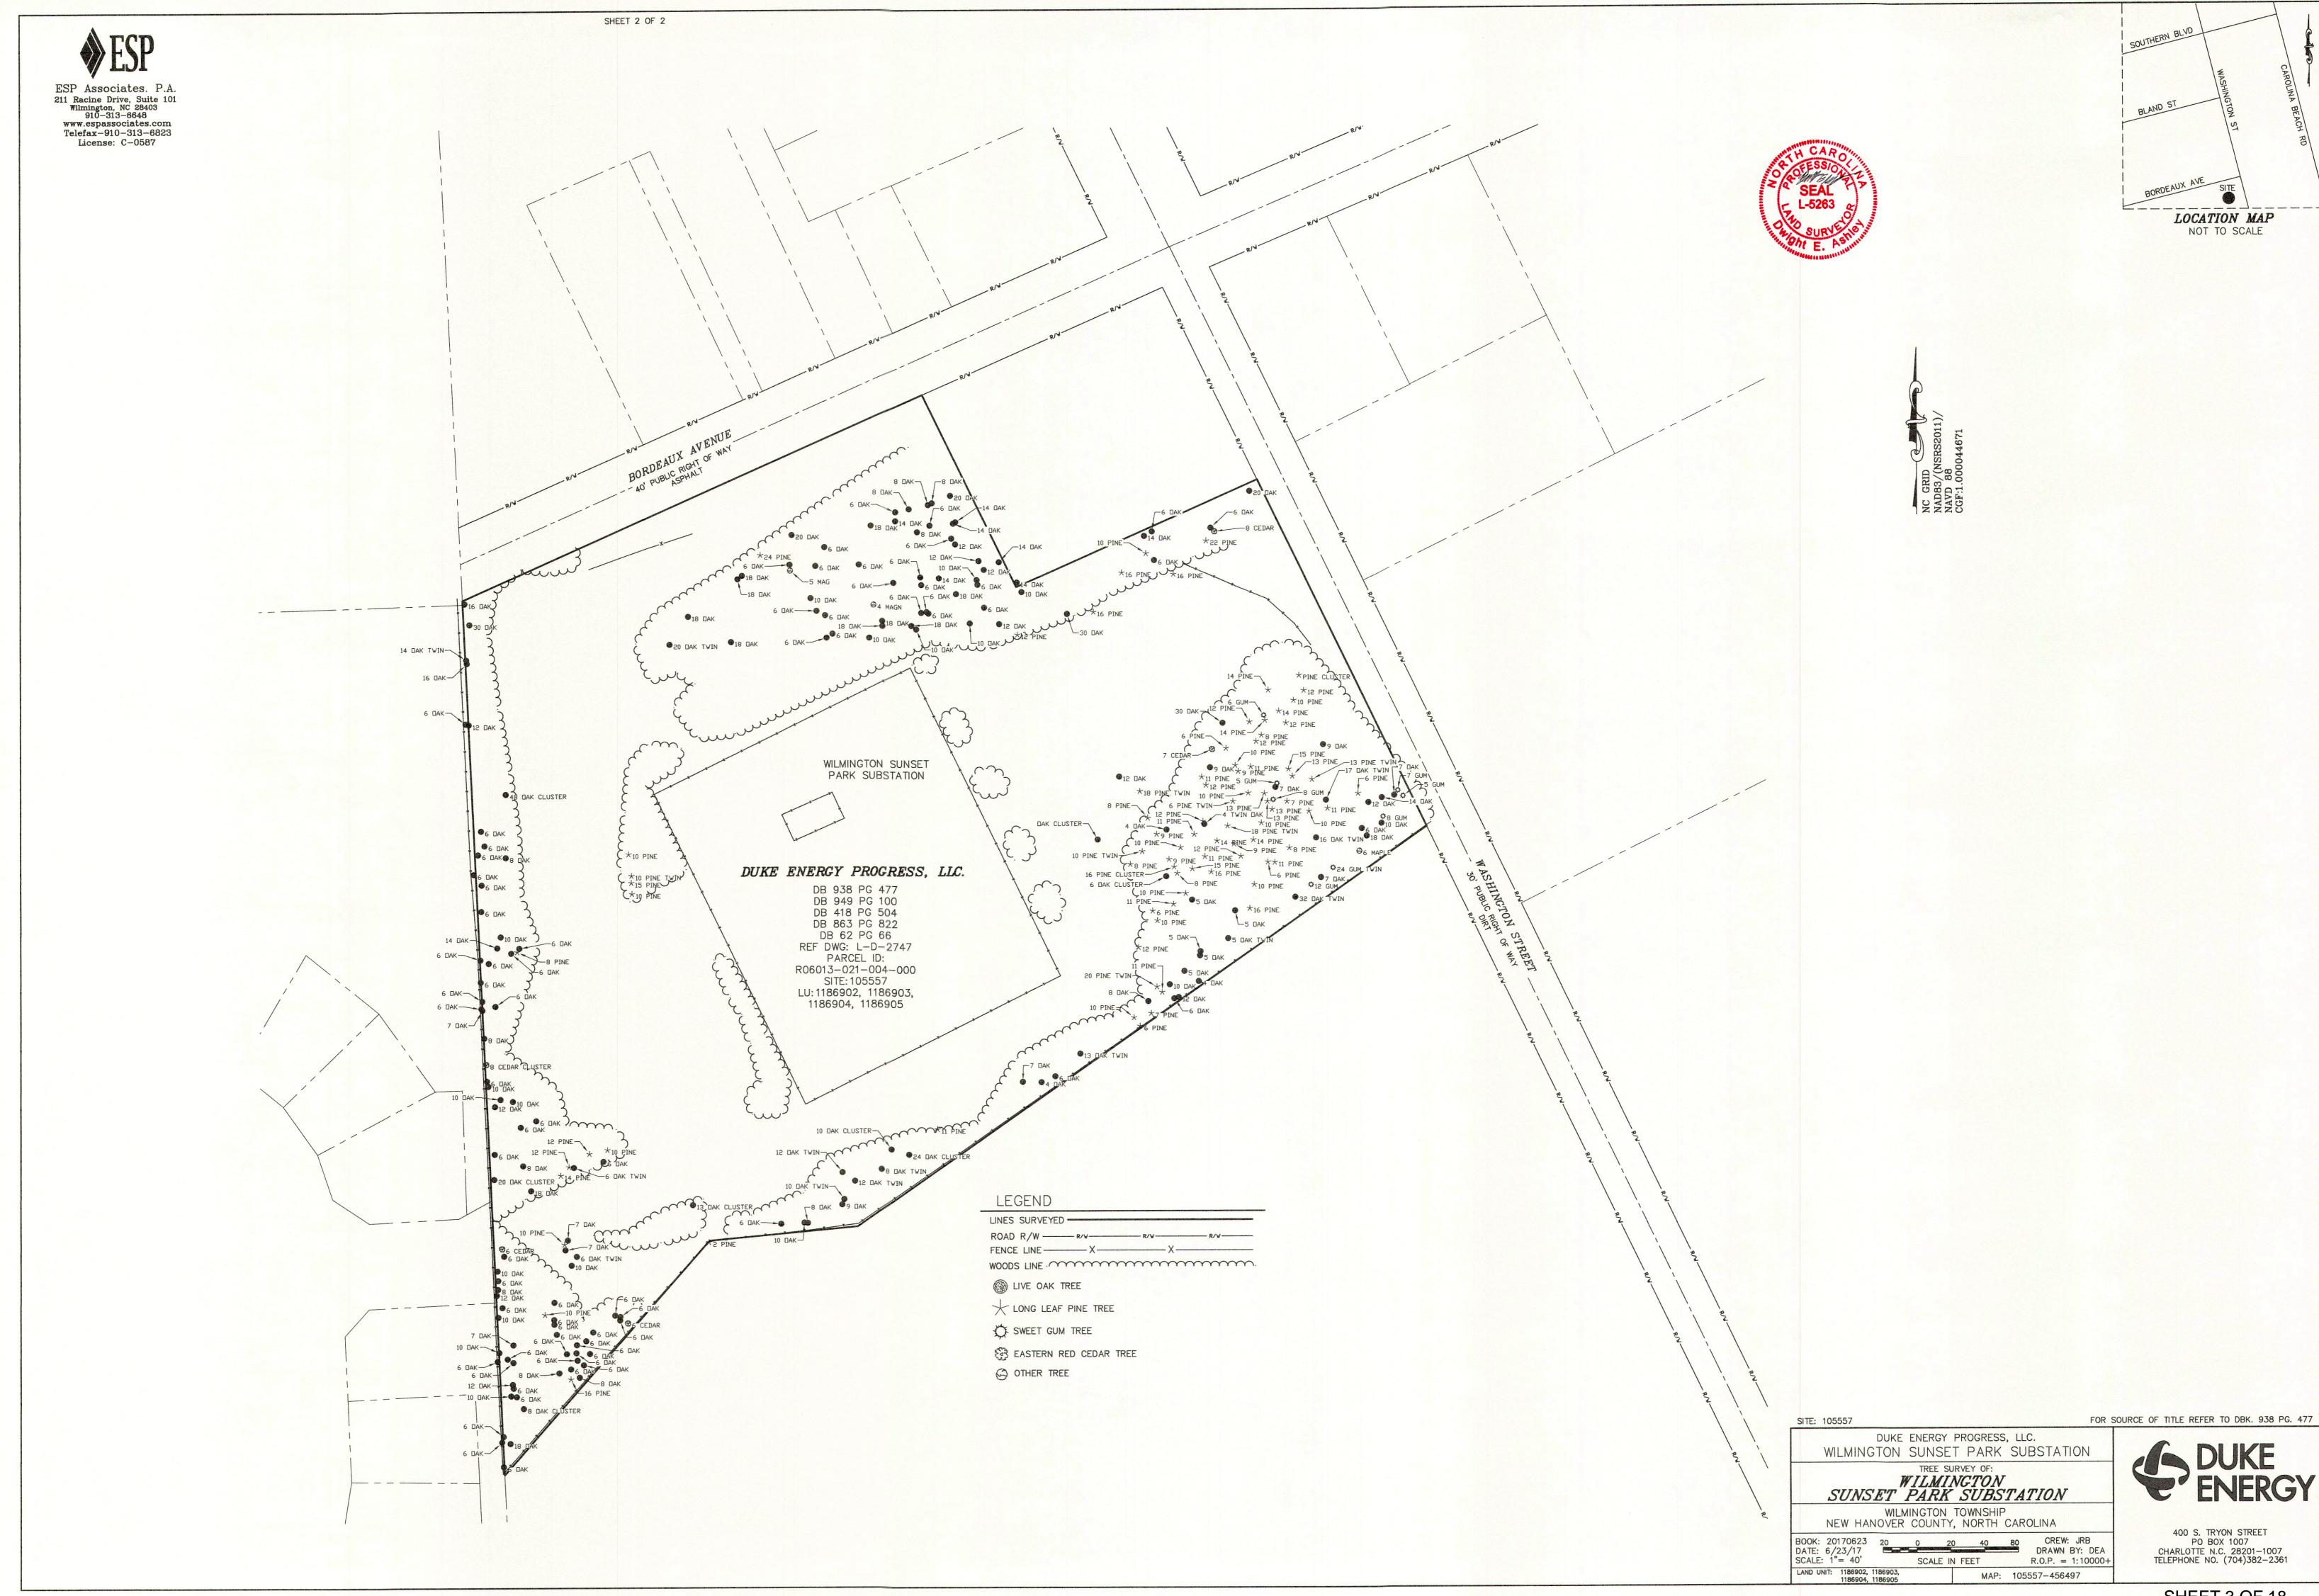

CITY OF WILMINGTON STANDARD NOTES

- PRIOR TO ANY CLEARING, GRADING OR CONSTRUCTION ACTIVITY, TREE PROTECTION FENCING SHALL BE INSTALLED AROUND PROTECTED TREES OR GROVES OF TREES. NO CONSTRUCTION WORKERS, TOOLS, MATERIALS, OR VEHICLES ARE PERMITTED WITHIN THE TREE PROTECTION FENCING.
- 2. ANY TREES AND/OR AREAS DESIGNATED TO BE PROTECTED MUST BE PROPERLY BARRICADED WITH FENCING AND PROTECTED THROUGHOUT CONSTRUCTION TO INSURE THAT NO CLEARING, GRADING OR STAGING OF MATERIALS WILL OCCUR IN THOSE AREAS.
- 3. NO EQUIPMENT IS ALLOWED ON SITE UNTIL ALL TREE PROTECTION FENCING AND SILT FENCING IS INSTALLED AND APPROVED. PROTECTIVE FENCING IS TO BE MAINTAINED THROUGHOUT THE DURATION OF THE PROJECT, AND CONTRACTORS SHALL RECEIVE ADEQUATE INSTRUCTION ON TREE PROTECTION
- 4. ALL PAVEMENT MARKINGS IN PUBLIC RIGHTS-OF-WAY AND FOR DRIVEWAYS ARE TO BE THERMOPLASTIC AND MEET CITY AND/OR NCDOT STANDARDS.
- 5. ONCE STREETS ARE OPEN TO TRAFFIC, CONTACT TRAFFIC ENGINEERING REGARDING THE INSTALLATION OF TRAFFIC AND STREET NAME SIGNS PROPOSED STREET NAMES MUST BE APPROVED PRIOR TO INSTALLATION OF STREET NAME SIGNS.
- 6. TRAFFIC CONTROL DEVICES (INCLUDING SIGNS AND PAVEMENT MARKINGS) IN AREAS OPEN TO PUBLIC TRAFFIC ARE TO MEET MUTCD (MANUAL ON UNIFORM TRAFFIC CONTROL DEVICES) STANDARDS.
- 7. CONTACT TRAFFIC ENGINEERING AT 910-341-7888 TO ENSURE THAT ALL TRAFFIC SIGNAL FACILITIES AND EQUIPMENT ARE SHOWN ON THE PLAN.
- 8. CALL TRAFFIC ENGINEERING AT 910-341-7888 FORTY-EIGHT (48) HOURS PRIOR TO ANY EXCAVATION IN THE RIGHT-OF-WAY.
- 9. TRAFFIC ENGINEERING MUST APPROVE OF PAVEMENT MARKING PRIOR TO ACTUAL STRIPING.
- 10. ALL PARKING STALL MARKINGS AND LANE ARROWS WITHIN THE PARKING AREAS SHALL BE WHITE.
- 11. ALL TRAFFIC CONTROL SIGNS AND MARKINGS OFF THE RIGHT-OF-WAY ARE TO BE MAINTAINED BY THE
- 12. STOP SIGNS AND STREET SIGNS TO REMAIN IN PLACE DURING CONSTRUCTION.
- 13. TACTILE WARNING MATS WILL BE INSTALLED ON ALL WHEELCHAIR RAMPS.
- 14. A UTILITY CUT PERMIT IS REQUIRED FOR EACH OPEN CUT OF A CITY STREET.
- 15. ANY BROKEN OR MISSING SIDEWALK PANELS, DRIVEWAY PANELS, AND CURBING WILL BE REPLACED.
- 16. CONTACT TRAFFIC ENGINEERING AT 910-341-7888 TO DISCUSS STREET LIGHTING OPTIONS.
- 17. WATER AND SEWER SERVICE SHALL MEET CAPE FEAR PUBLIC UTILITY AUTHORITY (CFPUA) DETAILS AND SPECIFICATIONS.
- 18. PROJECT SHALL COMPLY WITH CFPUA CROSS CONNECTION CONTROL REQUIREMENTS. WATER METER(S) CANNOT BE RELEASED UNTIL ALL REQUIREMENTS ARE MET AND THE STATE HAS GIVEN THEIR FINAL
- APPROVAL. CALL 910-343-3910 FOR INFORMATION.
- 19. IF THE CONTRACTOR DESIRES CFPUA WATER FOR CONSTRUCTION, HE SHALL APPLY IN ADVANCE FOR THIS SERVICE AND MUST PROVIDE A REDUCED PRESSURE ZONE (RPZ) BACKFLOW PREVENTION DEVICE ON THE DEVELOPER'S SIDE OF THE WATER METER BOX.
- 20. ANY IRRIGATION SYSTEM SUPPLIED BY CFPUA WATER SHALL COMPLY WITH THE CFPUA CROSS CONNECTION CONTROL REGULATIONS. CALL 919-343-3910 FOR INFORMATION.
- 21. ANY IRRIGATION SYSTEM SHALL BE EQUIPPED WITH A RAIN AND FREEZER SENSOR.
- 22. ANY BACKFLOW PREVENTION DEVICES REQUIRED BY THE CFPUA WILL NEED TO BE ON THE LIST OF APPROVED DEVICES BY USCFCCCHR OR ASSE.
- 23. CONTRACTOR TO FIELD VERIFY EXISTING WATER AND SEWER SERVICE LOCATIONS, SIZES AND MATERIALS PRIOR TO CONSTRUCTION, ENGINEER TO BE NOTIFIED OF ANY CONFLICTS.
- 24. CONTRACTOR SHALL MAINTAIN ALL-WEATHER ACCESS FOR EMERGENCY VEHICLES AT ALL TIMES DURING CONSTRUCTION.
- 25. UNDERGROUND FIRE LINE(S) MUST BE PERMITTED AND INSPECTED BY THE WILMINGTON FIRE DEPARTMENT FROM THE PUBLIC RIGHT-OF-WAY TO THE BUILDING. CONTACT THE WILMINGTON FIRE DEPARTMENT DIVISION OF FIRE AND LIFE SAFETY AT 910-341-0696.
- 26. NO OBSTRUCTIONS ARE PERMITTED IN THE SPACE BETWEEN THIRTY (30) INCHES AND TEN (10) FEET ABOVE THE GROUND WITHIN THE TRIANGULAR SIGHT DISTANCE.
- 27. CONTACT THE NORTH CAROLINA ONE CALL CENTER AT 1-800-632-4949 PRIOR TO DOING ANY DIGGING, CLEARING, OR GRADING
- 28. EXTERIOR LIGHTING MUST BE INSTALLED SO AS NOT TO SHINE ONTO ADJACENT RESIDENTIALLY USED

GROUND STAB	LIZATION	
SITE AREA DESCRIPTION	STABILIZATION TIME FRAME	STABILIZATION TIME FRAME EXCEPTIONS
PERIMETER DIKES, SWALES, DITCHES AND SLOPES	7 DAYS	NONE
HIGH QUALITY WATER (HQW) ZONES	7 DAYS	NONE
SLOPES STEEPER THAN 3:1	7 DAYS	IF SLOPES ARE 10' OR LESS IN LENGTH AND ARE NOT STEEPER THAN 2:1, 14 DAYS ARE ALLOWED
SLOPES 3:1 OR FLATTER	14 DAYS	7-DAYS FOR SLOPES GREATER THAN 50 FEET IN LENGTH
ALL OTHER AREAS WITH SLOPES FLATTER THAN 4:1	14 DAYS	NONE (EXCEPT FOR PERIMETERS AND HOW ZONES)

BUILDING WASTES HANDLING

AVAILABLE

- NO PAINT OR LIQUID WASTES IN STREAM OR STORM DRAINS DEDICATED AREAS FOR DEMOLITION. CONSTRUCTION AND OTHER WASTES MUST BE LOCATED 50' FROM STORM DRAINS AND STREAMS UNLESS NO REASONABLE ALTERNATIVES
- EARTHEN-MATERIAL STOCKPILES MUST BE LOCATED 50' FROM STORM DRAINS AND STREAMS UNLESS NO REASONABLE ALTERNATIVES
- CONCRETE MATERIALS MUST BE CONTROLLED TO AVOID CONTACT WITH SURFACE WATER, WETLANDS, OR BUFFFRS

EROSION CONTROL NARRATIVE

DUKE ENERGY PROGRESS WILMINGTON SUNSET PARK 115 KV SUBSTATION EXPANSION RECEIVING STREAM - GREENFIELD LAKE RIVER BASIN - CAPE FEAR

PROJECT NUMBER: DKE-17010 DESIGNED BY: CURT BLAZIER, PE

CLASSIFICATION - C,SW

PROJECT DESCRIPTION

THE PROPOSED PROJECT CONSISTS OF THE CONSTRUCTION OF A NEW TWO TRANSFORMER BANK SUBSTATION AND THE DEMOLITION OF THE EXISTING SUBSTATION. THE PROJECT WILL INCLUDE A STORMWATER MANAGEMENT FACILITY AND WILL COMPLY WITH CITY OF WILMINGTON ORDINANCE RUNOFF AND PEAK FLOW REGULATIONS. THIS SUBSTATION PROJECT IS BEING IMPLEMENTED TO MEET CURRENT AND FUTURE VOLTAGE LOAD DEMANDS IN THE SURROUNDING AREAS.

SEEDBED PREPARATION

AREAS TO BE SEEDED TO BE SCARIFIED 4" DEEP. A FIRM, WELL PULVERIZED, UNIFORM SEEDBED SHOULD BE PROVIDED. FERTILIZER SHALL BE PLACED DURING SCARIFICATION AS FOLLOWS

LIME: 45 LBS / 1,000 SF PHOSPHOROUS: 20 LBS / 1.000 SF FERTILIZER: 17 LBS / 1,000 SF

PER NORTH CAROLINA SOIL AND SEDIMENTATION LAW, A VEGETATIVE GROUNDCOVER SUFFICIENT TO PERMANENTLY RESTRAIN EROSION SHALL BE RE-ESTABLISHED WITHIN 21 CALENDAR DAYS AFTER COMPLETION OF ANY PHASE OF GRADING. PERMANENT GROUNDCOVER FOR ALL DISTURBED AREAS WITHIN 15 WORKING DAYS OR 90 CALENDAR DAYS (WHICHEVER IS SHORTER) FOLLOWING COMPLETION OF CONSTRUCTION OR DEVELOPMENT.

TEMPORARY AND PERMANENT SEEDING SCHEDULE

SEE DETAIL ON SHEET 10 FOR SEASONAL RATES, APPLICATION PROCEDURES, AND MAINTENANCE

EROSION CONTROL NOTES

- 1. EROSION AND SEDIMENT CONTROL DEVICES MUST BE INSTALLED AND INSPECTED PRIOR TO ANY GRADING ON SITE. THE CONTRACTOR SHALL CALL FOR A INSPECTION ONCE INITIAL MEASURES ARE IN
- 2. SEDIMENT/EROSION CONTROL DEVICES MUST BE CHECKED AFTER EACH STORM EVENT. EACH DEVICE IS TO BE MAINTAINED OR REPLACED IF SEDIMENT ACCUMULATION HAS REACHED ONE HALF THE CAPACITY
- 3. THE PERMANENT STORM DRAINAGE SWALES ARE TO BE MATTED IMMEDIATELY UPON CONSTRUCTION.
- 4. A COPY OF THE APPROVED EROSION CONTROL PLAN MUST BE ON FILE AT THE JOB SITE AT ALL
- 5. INSTALL A RAIN GAUGE (6" CAPACITY OR GREATER) ONSITE.
- 6. CONSTRUCTION, MAINTENANCE, AND REMOVAL OF ALL EROSION CONTROL DEVICES ARE THE RESPONSIBILITY OF THE GRADING CONTRACTOR UNLESS OTHERWISE NOTED.
- 7. ANY GRADING BEYOND THE DENUDED LIMITS SHOWN ON THE PLAN IS A VIOLATION OF THE EROSION CONTROL PERMIT AND IS SUBJECT TO A FINE.
- 8. DISTURBED AREAS MUST BE STABILIZED AS SOON AS POSSIBLE AND NO LATER THAN 14 DAYS. TEMPORARY SEEDING IS NECESSARY TO ACHIEVE EROSION CONTROL ON LARGE DENUDED AREAS AND ESPECIALLY WHEN SPECIFICALLY REQUIRED AS PART OF THE CONSTRUCTION SEQUENCE ON THE PLAN. ALL GRADED SLOPES STEEPER THAN 3:1 MUST BE SEEDED & MULCHED AND TACKIFIER PLACED WITHIN 7 DAYS OF COMPLETION OF GRADING. ALL REMAINING DISTURBED AREAS ARE TO BE SEEDED AND MULCHED WITHIN 14 DAYS. SEE THE GROUND STABILIZATION CHART FOR ADDITIONAL REQUIREMENTS.
- ADDITIONAL MEASURES TO CONTROL EROSION AND SEDIMENT MAY BE REQUIRED BY CITY OF WILMINGTON AND/OR A REPRESENTATIVE OF THE NCDEQ DEMLR DEPARTMENT.
- 10. PROTECTION OF EXISTING VEGETATION: AT THE START OF GRADING INVOLVING THE STRIPPING OF TOPSOIL OR LOWERING OF EXISTING GRADE AROUND A TREE, A CLEAN, SHARP, VERTICAL CUT SHALL BE MADE AT THE EDGE OF THE TREE SAVE AREA AT THE SAME TIME AS OTHER EROSION CONTROL MEASURES ARE INSTALLED. THE TREE PROTECTION FENCING SHALL BE INSTALLED ON THE SIDE OF THE CUT FARTHEST AWAY FROM THE TREE TRUNK AND SHALL REMAIN IN PLACE UNTIL ALL CONSTRUCTION IN THE VICINITY OF THE TREES IS COMPLETE. NO STORAGE OF MATERIALS, FILL, OR EQUIPMENT AND NO TRESPASSING SHALL BE ALLOWED WITHIN THE BOUNDARY OF THE PROTECTED AREA AND SHALL BE POSTED ON THE PROTECTION FENCE. A PROTECTION FENCE CONSTRUCTED OF MATERIAL RESISTANT TO DEGRADATION BY SUN, WIND, AND MOISTURE FOR THE DURATION OF THE CONSTRUCTION, SHALL BE INSTALLED AT THE SAME TIME AS THE EROSION CONTROL MEASURES AND SHALL BE IN PLACE UNTIL ALL CONSTRUCTION IN THE VICINITY OF THE TREES IS COMPLETE
- 11. INSTALLATION AND MAINTENANCE OF ALL PROPOSED SEDIMENTATION & EROSION CONTROL MEASURES IS REQUIRED. THE CONTRACTOR MAY BE ALLOWED, WITH PRIOR APPROVAL FROM THE OWNER, TO COORDINATE CHANGES TO THE PLAN WITH THE ON-SITE NCDEQ DEMLR INSPECTOR AND THE ENGINEER OR THE OWNER'S REPRESENTATIVE
- 12. CONTRACTOR WILL FIELD LOCATE SILT FENCE OUTLETS AT LOW POINTS IN SILT FENCE AS REQUIRED TO PROVIDE RELIEF FROM CONCENTRATED FLOWS.
- 13. ALL DIMENSIONS AND GRADES SHOWN ON THE PLANS SHALL BE FIELD VERIFIED BY THE CONTRACTOR PRIOR TO CONSTRUCTION, CONTRACTOR SHALL NOTIFY THE OWNER IF ANY DISCREPANCIES EXIST PRIOR TO PROCEEDING WITH CONSTRUCTION FOR NECESSARY PLAN OR GRADE CHANGES. NO EXTRA COMPENSATION SHALL BE PAID TO THE CONTRACTOR FOR ANY WORK DONE DUE TO DIMENSIONS OR GRADES SHOWN INCORRECTLY ON THESE PLANS IF SUCH NOTIFICATION HAS NOT BEEN GIVEN.
- 14. REQUIRED TREE PROTECTION FENCING SHALL BE INSTALLED PRIOR TO BEGINNING LAND DISTURBANCE.
- 15. IT IS THE RESPONSIBILITY OF THE CONTRACTOR TO KEEP ALL DIRT OFF PAVED ROADS. HEAVY MATS MAY BE USED IN LIEU OF ROCK CONSTRUCTION ENTRANCES AS DETERMINED BY THE ON-SITE
- 16. IT IS THE RESPONSIBILITY OF THE CONTRACTOR TO KEEP ALL SEDIMENT ON SITE AND ENSURE NO SEDIMENT LEAVES THE LIMITS OF DISTURBANCE OF THE PROJECT. THIS MAY REQUIRE INSTALLATION OF ADDITIONAL EROSION CONTROL MEASURES ABOVE AND BEYOND WHAT IS SHOWN ON THE PLANS. IF ENVIRONMENTAL OR SITE CONDITIONS WARRANT ADDITIONAL EROSION CONTROL MEASURES, CONTRACTOR SHALL OBTAIN PRIOR APPROVAL FROM DEP REPRESENTATIVE, EROSION CONTROL MEASURES DAMAGED OR REQUIRED DUE TO CONTRACTOR ACTIONS SHALL BE THE RESPONSIBILITY OF THE CONTRACTOR. ALL EROSION CONTROL MEASURES SHALL BE PROPERLY MAINTAINED THROUGHOUT CONSTRUCTION AT NO ADDITIONAL COST TO DEP.
- 17. ALL CONSTRUCTION DEBRIS SHALL BE TESTED AND DISPOSED OF OFF-SITE IN A STATE PERMITTED LINED LANDFILL.
- 18. IMMEDIATE CLEANUP OF ANY MATERIAL BEING PLACED ON THE ROADWAY AS WELL AS IMMEDIATE SEEDING/COVER PLACED ON DISTURBED GROUND BETWEEN THE SILT FENCE AND SIDEWALK IS REQUIRED.

MAINTENANCE PLAN

- ALL EROSION AND SEDIMENT CONTROL MEASURES WILL BE CHECKED FOR STABILITY AND OPERATION FOLLOWING EVERY RUNOFF-PRODUCING RAINFALL BUT IN NO CASE LESS THAN ONCE EVERY WEEK. ANY NEEDED REPAIRS SHALL BE MADE IMMEDIATELY TO MAINTAIN ALL MEASURES AS
- SEDIMENT FENCES SHALL BE INSPECTED AT LEAST ONCE A WEEK AND AFTER EACH RAINFALL REPAIRS SHALL BE MADE IMMEDIATELY. SEDIMENT DEPOSITS SHALL BE REMOVED AS NEEDED TO PROVIDE ADEQUATE STORAGE VOLUME FOR THE NEXT RAINFALL EVENT, AND TO REDUCE PRESSURE ON THE FENCE. FENCING MATERIALS AND SEDIMENT DEPOSITS SHALL BE REMOVED. AND THE AREA BROUGHT TO GRADE FOLLOWING STABILIZATION OF UPGRADIENT DISTURBED AREAS.

SITE NOTES

- 1. LOCATION AND TOPOGRAPHICAL INFORMATION WAS TAKEN FROM AN ACTUAL FIELD SURVEY PERFORMED BY ESP ASSOCIATES P.A., DATED 01/12/2017. REFERENCE DATUM IS NAD 83 (2011) HORIZONTAL AND NAVD 88 FOR VERTICAL.
- 2. PROPERTY LIES WITHIN FEMA ZONE X (OUTSIDE 500 YEAR FLOOD PLAIN) AS PER FEMA FIRM COMMUNITY PANEL NO. 3720312600J, REVISED DATE 04-03-06.
 - 3. PROJECT SITE IS LOCATED IN THE CAPE FEAR RIVER BASIN.
 - 4. ALL MATERIALS, CONSTRUCTION, WORKMANSHIP SHALL MEET CITY OF WILMINGTON, DUKE ENERGY PROGRESS, LLC (DEP), AND NCDOT (WHERE APPLICABLE) SPECIFICATIONS, STANDARDS AND DESIGN.
- 5. CONTRACTOR SHALL COMPLY WITH ALL PERTINENT PROVISIONS OF THE "MANUAL OF ACCIDENT PREVENTION IN CONSTRUCTION" ISSUED BY AGC OF AMERICA, INC., AND THE SAFETY AND HEALTH REGULATIONS FOR CONSTRUCTION ISSUED BY THE U.S. DEPARTMENT OF LABOR.
- 6. NOT ALL EXISTING UTILITIES ARE SHOWN, LOCATIONS SHOWN ARE APPROXIMATE. IT IS THE CONTRACTOR'S RESPONSIBILITY TO ACCURATELY LOCATE BOTH HORIZONTALLY AND VERTICALLY ALL EXISTING UTILITIES PRIOR TO THE START OF CONSTRUCTION. THE CONTRACTOR SHALL NOTIFY SC811 OR THEIR SUCCESSOR AT 888-721-7877 PRIOR TO EXCAVATION. CONTRACTOR SHALL NOTIFY DUKE ENERGY PROGRESS, INC. IMMEDIATELY IN THE EVENT OF ENCOUNTERING ANY UNDERGROUND OBSTACLE REQUIRING DEVIATION FROM THE PLAN. COST TO REPAIR DAMAGED UTILITIES SHALL BE BORNE BY THE
- 7. THE CONTRACTOR SHALL BE RESPONSIBLE FOR THE REPAIR OF ANY PAVEMENT OR EXISTING UTILITIES THAT MAY BE DAMAGED DUE TO CONSTRUCTION ACTIVITY. EXERCISE CAUTION.
- 8. SHOULD ANY GROUNDING BE CUT OR UNEARTHED, THE GROUNDING WILL NEED TO BE REPAIRED AND RECONNECTED. THE GROUNDING SHOULD BE BETWEEN 18" TO 24" DEPTH.
- 9. ALL UTILITIES SHALL BE PROTECTED AND REMAIN ACTIVE UNLESS OTHERWISE NOTED. CONTRACTOR SHALL NOT DISTURB UTILITY POLES, GUY WIRES, OR ANCHORS WITHOUT PERMISSION FOR DUKE ENERGY PROGRESS, INC.
- 10. EXISTING IMPROVEMENTS SLATED TO REMAIN THAT ARE DAMAGED DURING CONSTRUCTION SHALL BE REPLACED/RESTORED TO THEIR ORIGINAL CONDITION OR TO THE SATISFACTION OF THE OWNER BY THE CONTRACTOR RESPONSIBLE FOR THE DAMAGE.
- 11. FOUNDATIONS, FENCES AND LIGHTING BY OTHERS.
- 12. STRUCTURE LOCATIONS WERE PROVIDED BY DUKE ENERGY PROGRESS (DEP) AND ARE FOR REFERENCE ONLY. THESE DRAWINGS ARE FOR SITE GRADING, SUBSTATION PAD, AND ACCESS ROAD CONSTRUCTION ONLY AND SHALL NOT BE USED FOR LINE OR STRUCTURE CONSTRUCTION.
- 13. ALL SITE WORK SHALL CONFORM TO DUKE ENERGY STANDARDS AND SPECIFICATIONS.
- 14. DISTRIBUTION LINES ARE NOT SHOWN FOR CLARITY AT THIS TIME.

VISUAL SIGHT LINES FROM 30 INCHES TO 10 FEET.

- 15. ALL CONSTRUCTION DEBRIS SHALL BE TESTED AND DISPOSED OF OFF-SITE IN A STATE PERMITTED LINED LANDFILL OR AS DIRECTED BY DEP REPRESENTATIVE.
- 16. DRIVEWAYS OF EXISTING LOTS ACROSS BORDEAUX AVENUE TO REMAIN OPEN DURING CONSTRUCTION.
- 17. ALL PROPOSED VEGETATION WITHIN SIGHT DISTANCE TRIANGLES SHALL NOT INTERFERE WITH CLEAR
- 18. EXTERIOR LIGHTING MUST BE INSTALLED SO AS NOT TO SHINE ONTO ADJACENT PROPERTIES OF RESIDENTIAL USE/ZONING.
- 19. EXISTING OVERHEAD UTILITY POWER POLE TO REMAIN UNDISTURBED DURING SIDEWALK INSTALLATION ALONG BORDEAUX AVENUE. CONTRACTOR TO ADJUST CONCRETE FORMS AS NECESSARY TO WORK AROUND EXISTING POLE.


- CONTRACTOR SHALL CALL "NC811" 811 OR (800-632-4949) AT LEAST 3 FULL BUSINESS DAYS PRIOR TO MOBILIZATION TO HAVE EXISTING UTILITIES LOCATED. REPORT ANY DISCREPANCIES TO
- 2. CONTRACTOR SHALL EXERCISE EXTREME CAUTION WHEN WORKING UNDER, AROUND, AND/OR ADJACENT TO EXISTING POWER LINES.
- 3. STORM DRAINAGE PIPE SHALL BE CLASS IV RCP MIN. UNLESS OTHERWISE NOTED.
- 4. PROPOSED DRIVEWAY SHALL BE 12 INCHES OF COMPACTED ABC STONE.
- 5. PROPOSED SUBSTATION SUBGRADE SHALL BE COMPACTED ABC. THE DEPTH OF THIS LAYER WILL VARY DEPENDING ON EXISTING SUBSTATION STONE GRADE. FINAL STONE WITHIN SUBSTATION FENCE SHALL BE AN ADDITIONAL 3" OF CLEAN #57 OVER 3" ABC (TOTAL OF 6" ADDITIONAL
- 6. PROPOSED CONTOURS AND SPOT ELEVATIONS ARE FINISHED GRADE ELEVATIONS (TOP OF STONE, TOP OF GRASS, ETC) UNLESS OTHERWISE NOTED.
- 7. ALL SOILS SHALL BE COMPACTED TO AT LEAST 95% OF THE STANDARD PROCTOR MAXIMUM DRY DENSITY OR AS SPECIFIED IN THE GEOTECHNICAL REPORT, THE MORE STRINGENT SHALL APPLY.
- 8. FILL PLACEMENT SHOULD BE INITIATED AT THE TOE OF THE SLOPE, AND BENCHES SHALL BE CUT INTO EXISTING SOILS TO PROVIDE A HORIZONTAL SURFACE FOR COMPACTION. SLOPES SHALL BE OVERBUILT AND CUT BACK TO THE REQUIRED GRADE, LEAVING THE EXPOSED FACE WELL COMPACTED. VEGETATION SHALL BE ESTABLISHED AS SOON AS PRACTICAL ALONG ALL SLOPES. RAINWATER SHALL BE DIVERTED AWAY FROM THE CREST OF SLOPES TO REDUCE EROSION.
- 9. CONTRACTOR TO REFER TO GEOTECHNICAL REPORT FOR GUIDANCE IN SITEWORK COMPLETED BY S&ME, INC. DATED 4/10/17.
- 10. CUT MATERIAL SHALL BE STOCKPILED IN AREAS ON-SITE WHERE POSSIBLE. EXCESS MATERIAL THAT CANNOT BE SPOILED ON-SITE SHALL BE REMOVED AND DISPOSED OF PROPERLY OFFSITE.

STORM READY RESPONSIBILITIES

- 1. LEAVE ALL SITES WITH LAND DISTURBING ACTIVITY IN A "STORM READY STATE". CONTRACTORS SHOULD CONDUCT EXTRA INSPECTIONS TO ENSURE BMPS ARE IN PLACE BEFORE THEY LEAVE THE PROJECT SITE FOR THE DAY.
- 2. ENSURE SEDIMENT BASINS OR CONTAINMENTS HAVE ENOUGH FREEBOARD TO ACCOMMODATE HEAVY RAINS WITHOUT OVERFLOWING.
- 3. ONCE THE RAIN PASSES, ENSURE OPERATORS INSPECT AND DRAIN CONTAINMENTS AS NECESSARY. IF COLLECTED WATER IS SIGNIFICANTLY TURBID, CONSIDER A SLOW RELEASE RATE TO MINIMIZE ANY WATER QUALITY IMPACTS.
- 4. ALSO, ONCE THE RAIN PASSES, INSPECT THE SITE AND ANY EROSION CONTROL MEASURES TO ENSURE THERE HAVE NO SEDIMENT RELEASES. REPAIR AND RETURN TO DESIGN CONDITION ANY EROSION CONTROL MEASURES OR BMPS.
- 5. IF THERE IS POTENTIAL FOR GUSTY OR HIGH WINDS, MAKE SURE THAT ALL PORTABLE EQUIPMENT IS PROPERLY STORED OR TIED DOWN. THIS INCLUDES LIGHT EQUIPMENT OR SIMILAR EQUIPMENT WHICH COULD BLOW OVER IF THE MAST IS NOT LOWERED AS WELL AS PORTABLE TOILETS THAT COULD TIP OVER IF NOT TIED DOWN OR SECURED.

	<u>Name</u>	<u>Date</u>
Planning		
Traffic		
Fire		

Approved Construction Dlan

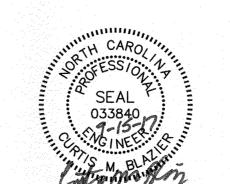



THE JOHN R. McADAMS COMPANY, INC.

FINAL DRAWING - NOT RELEASED FOR CONSTRUCTION


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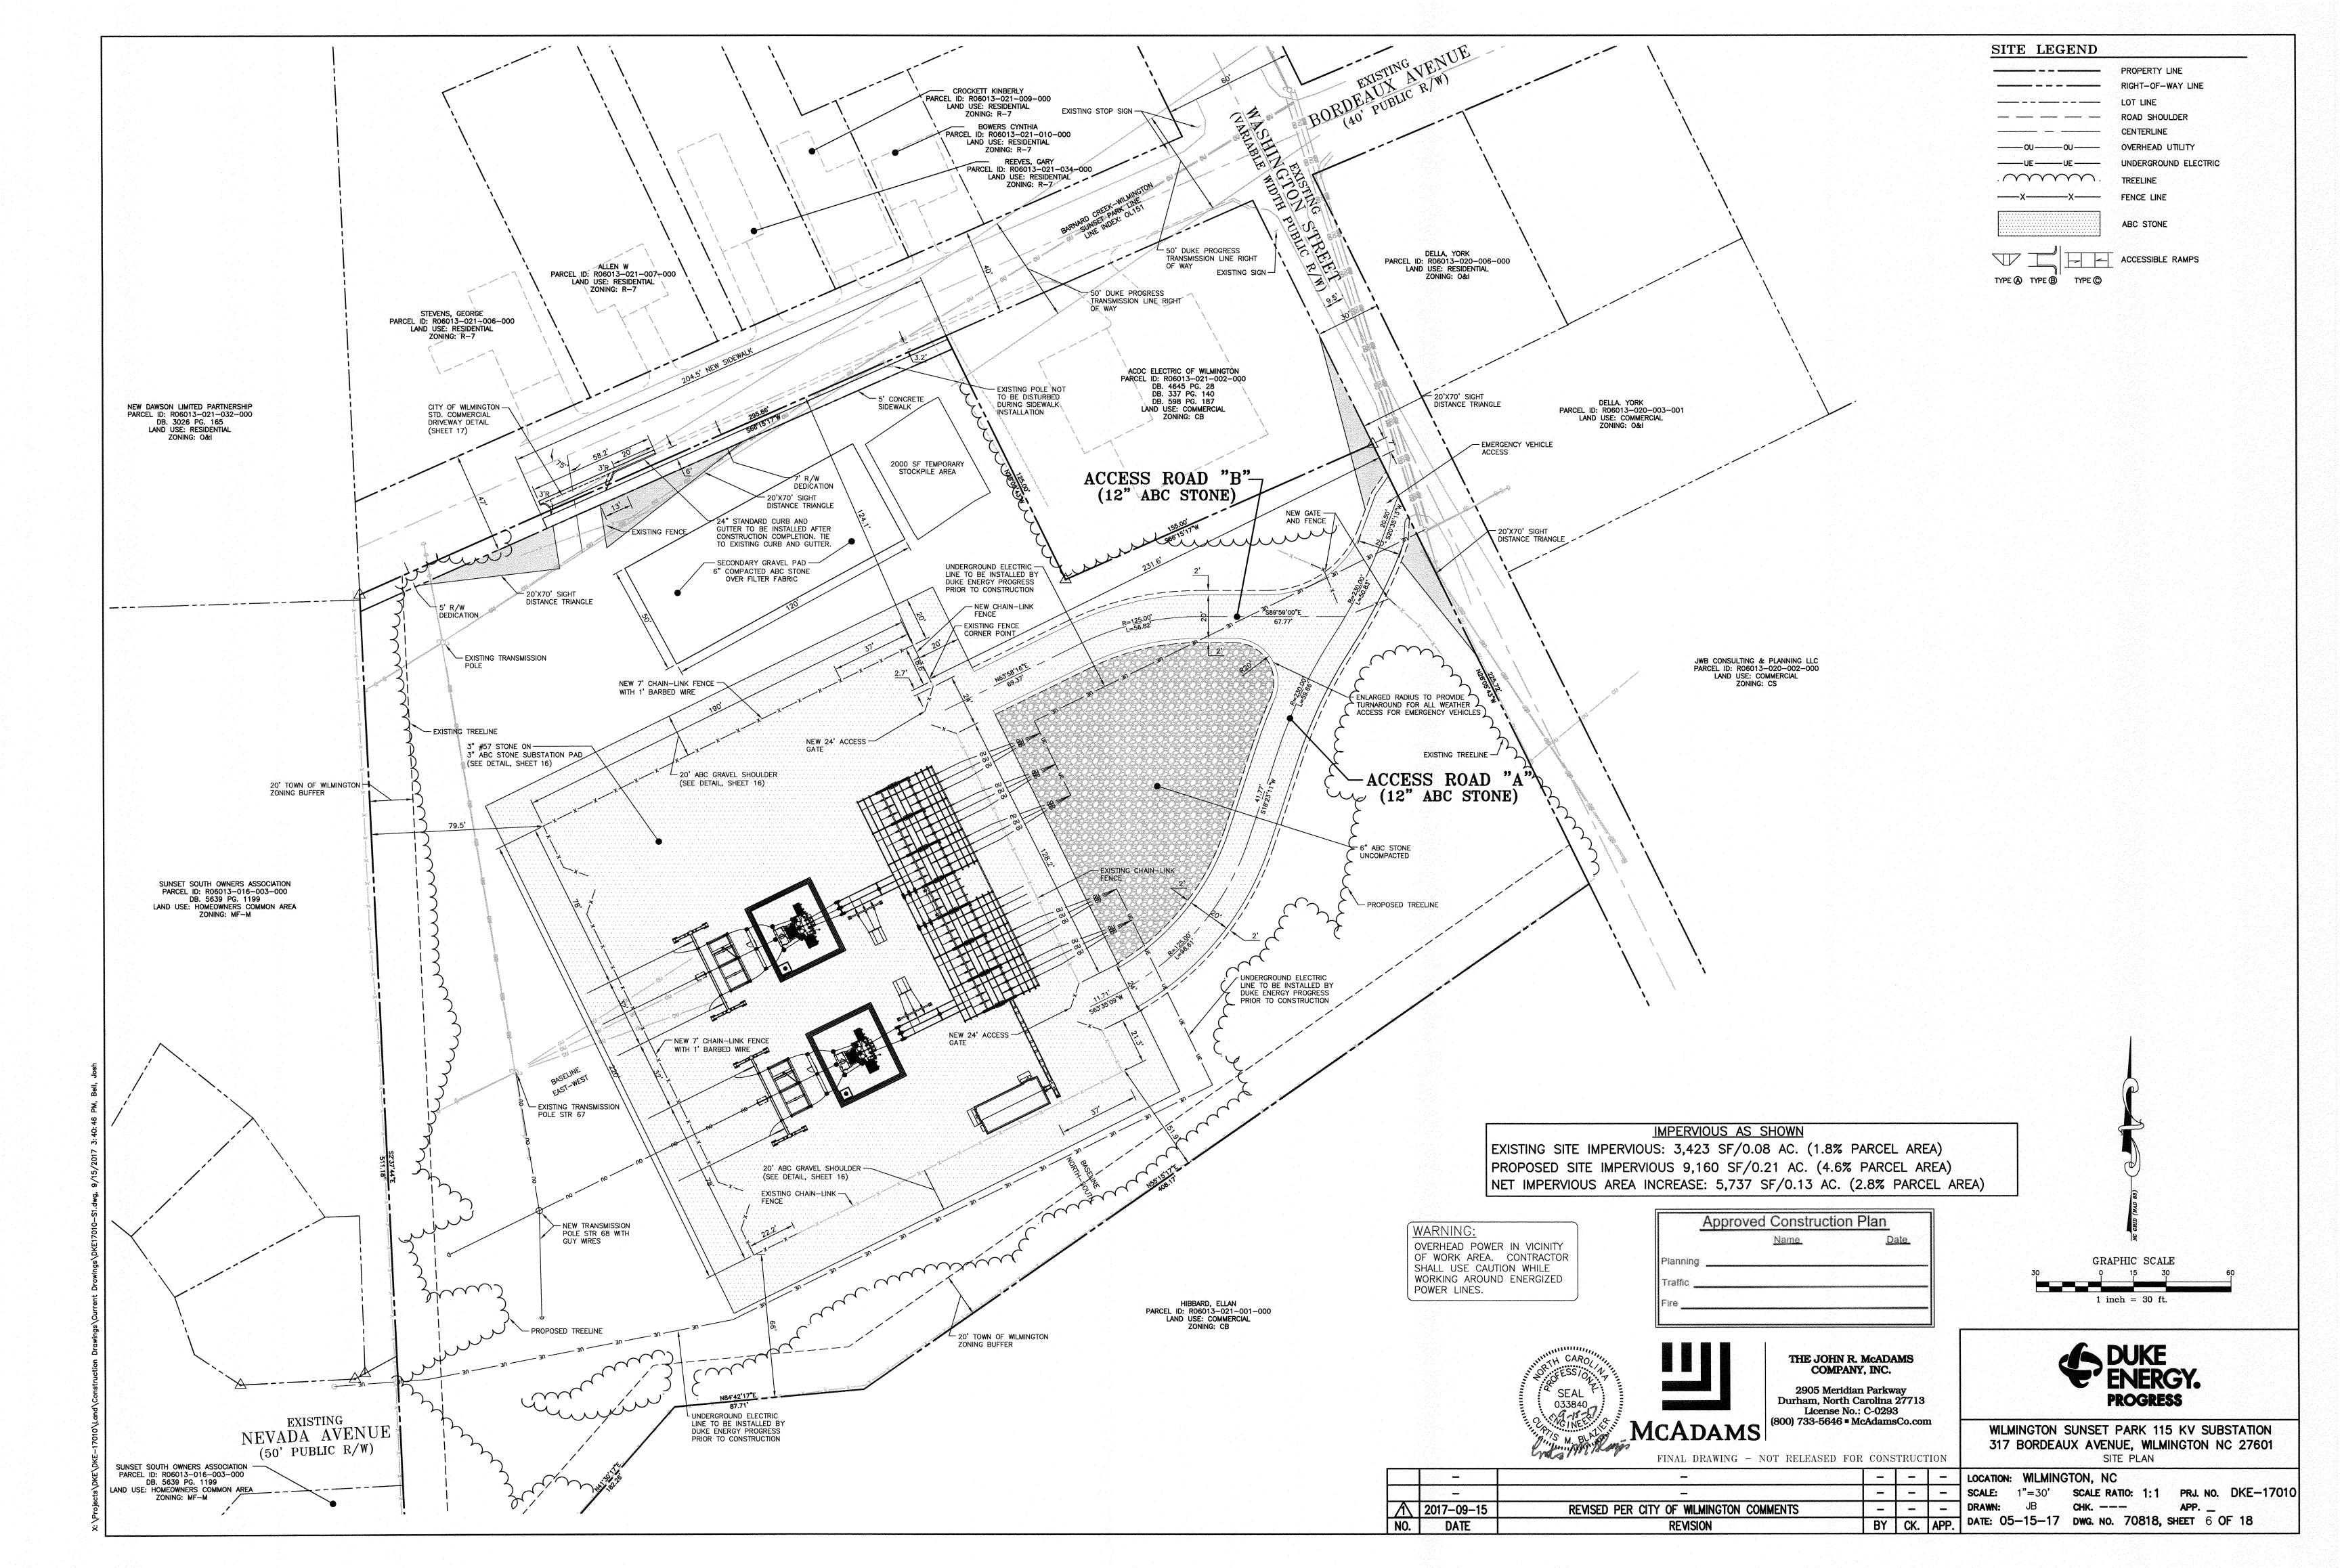



WILMINGTON SUNSET PARK 115 KV SUBSTATION 317 BORDEAUX AVENUE, WILMINGTON NC 27601 PROJECT NOTES


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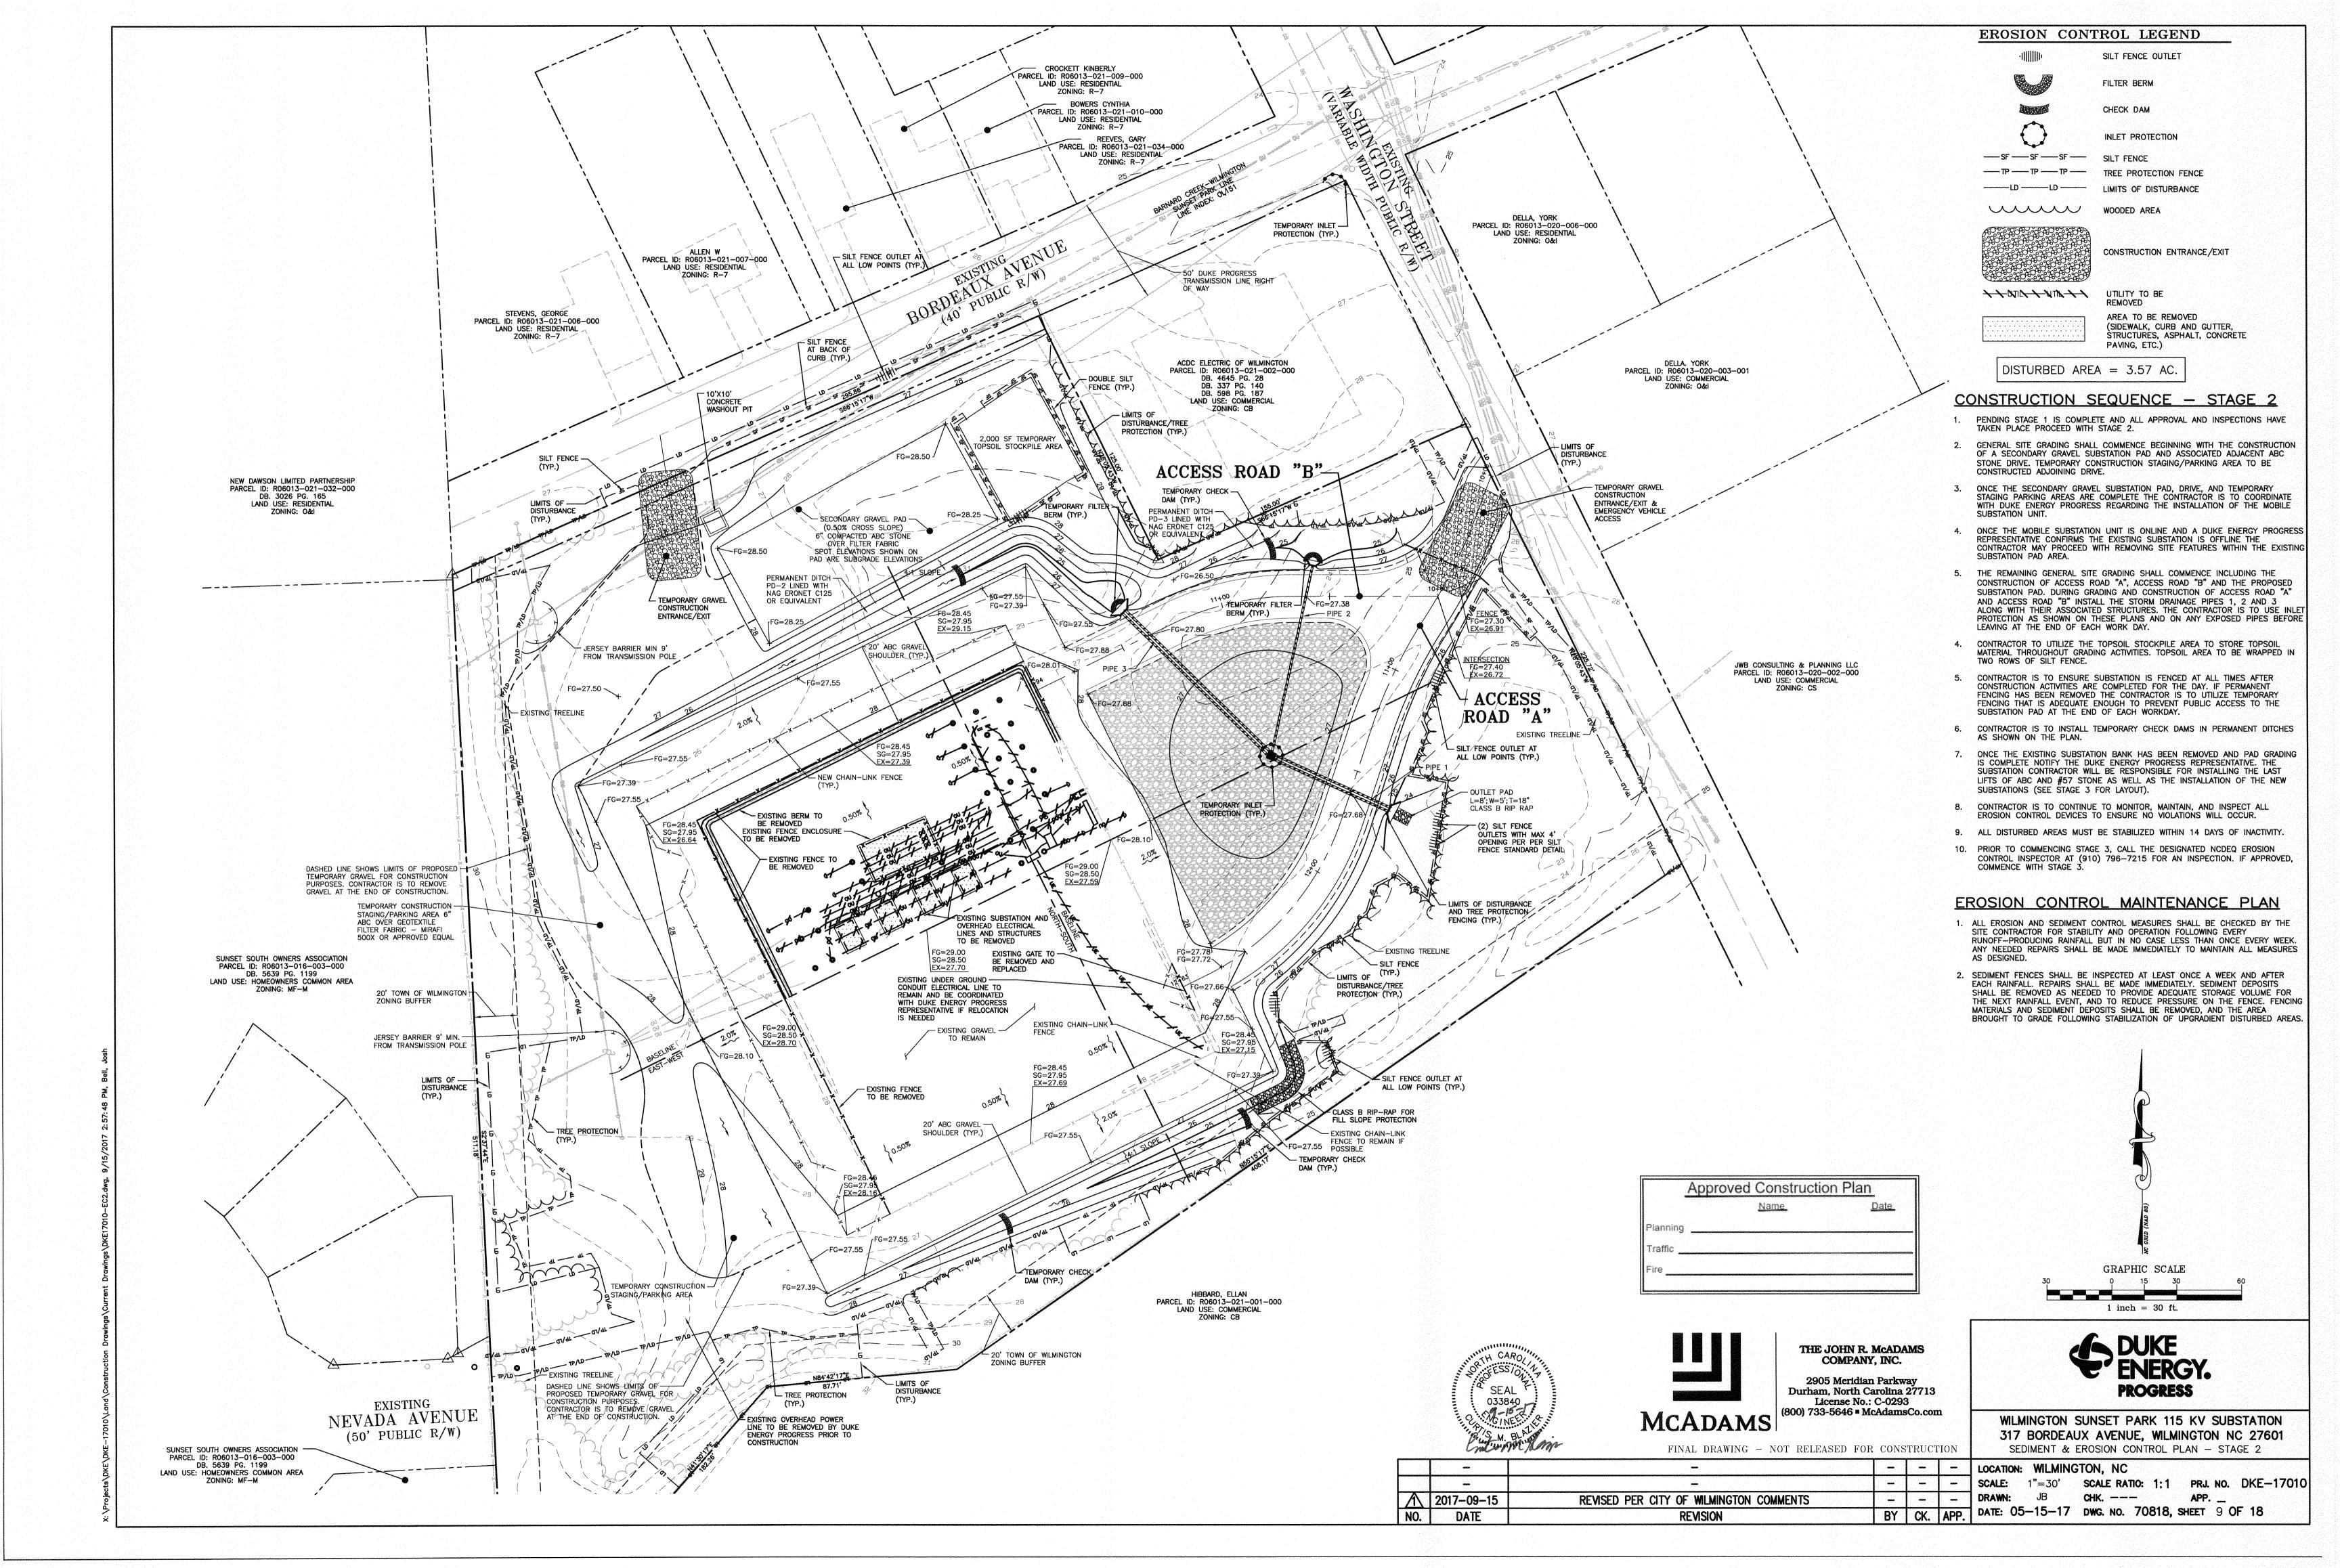
LOCATION: WILMINGTON, NC NTS SCALE RATIO: 1:1 PRJ. NO. DKE-17010 CHK. ---BY CK. APP. DATE: 05-15-17 DWG. NO. 70818, SHEET 4 OF 18







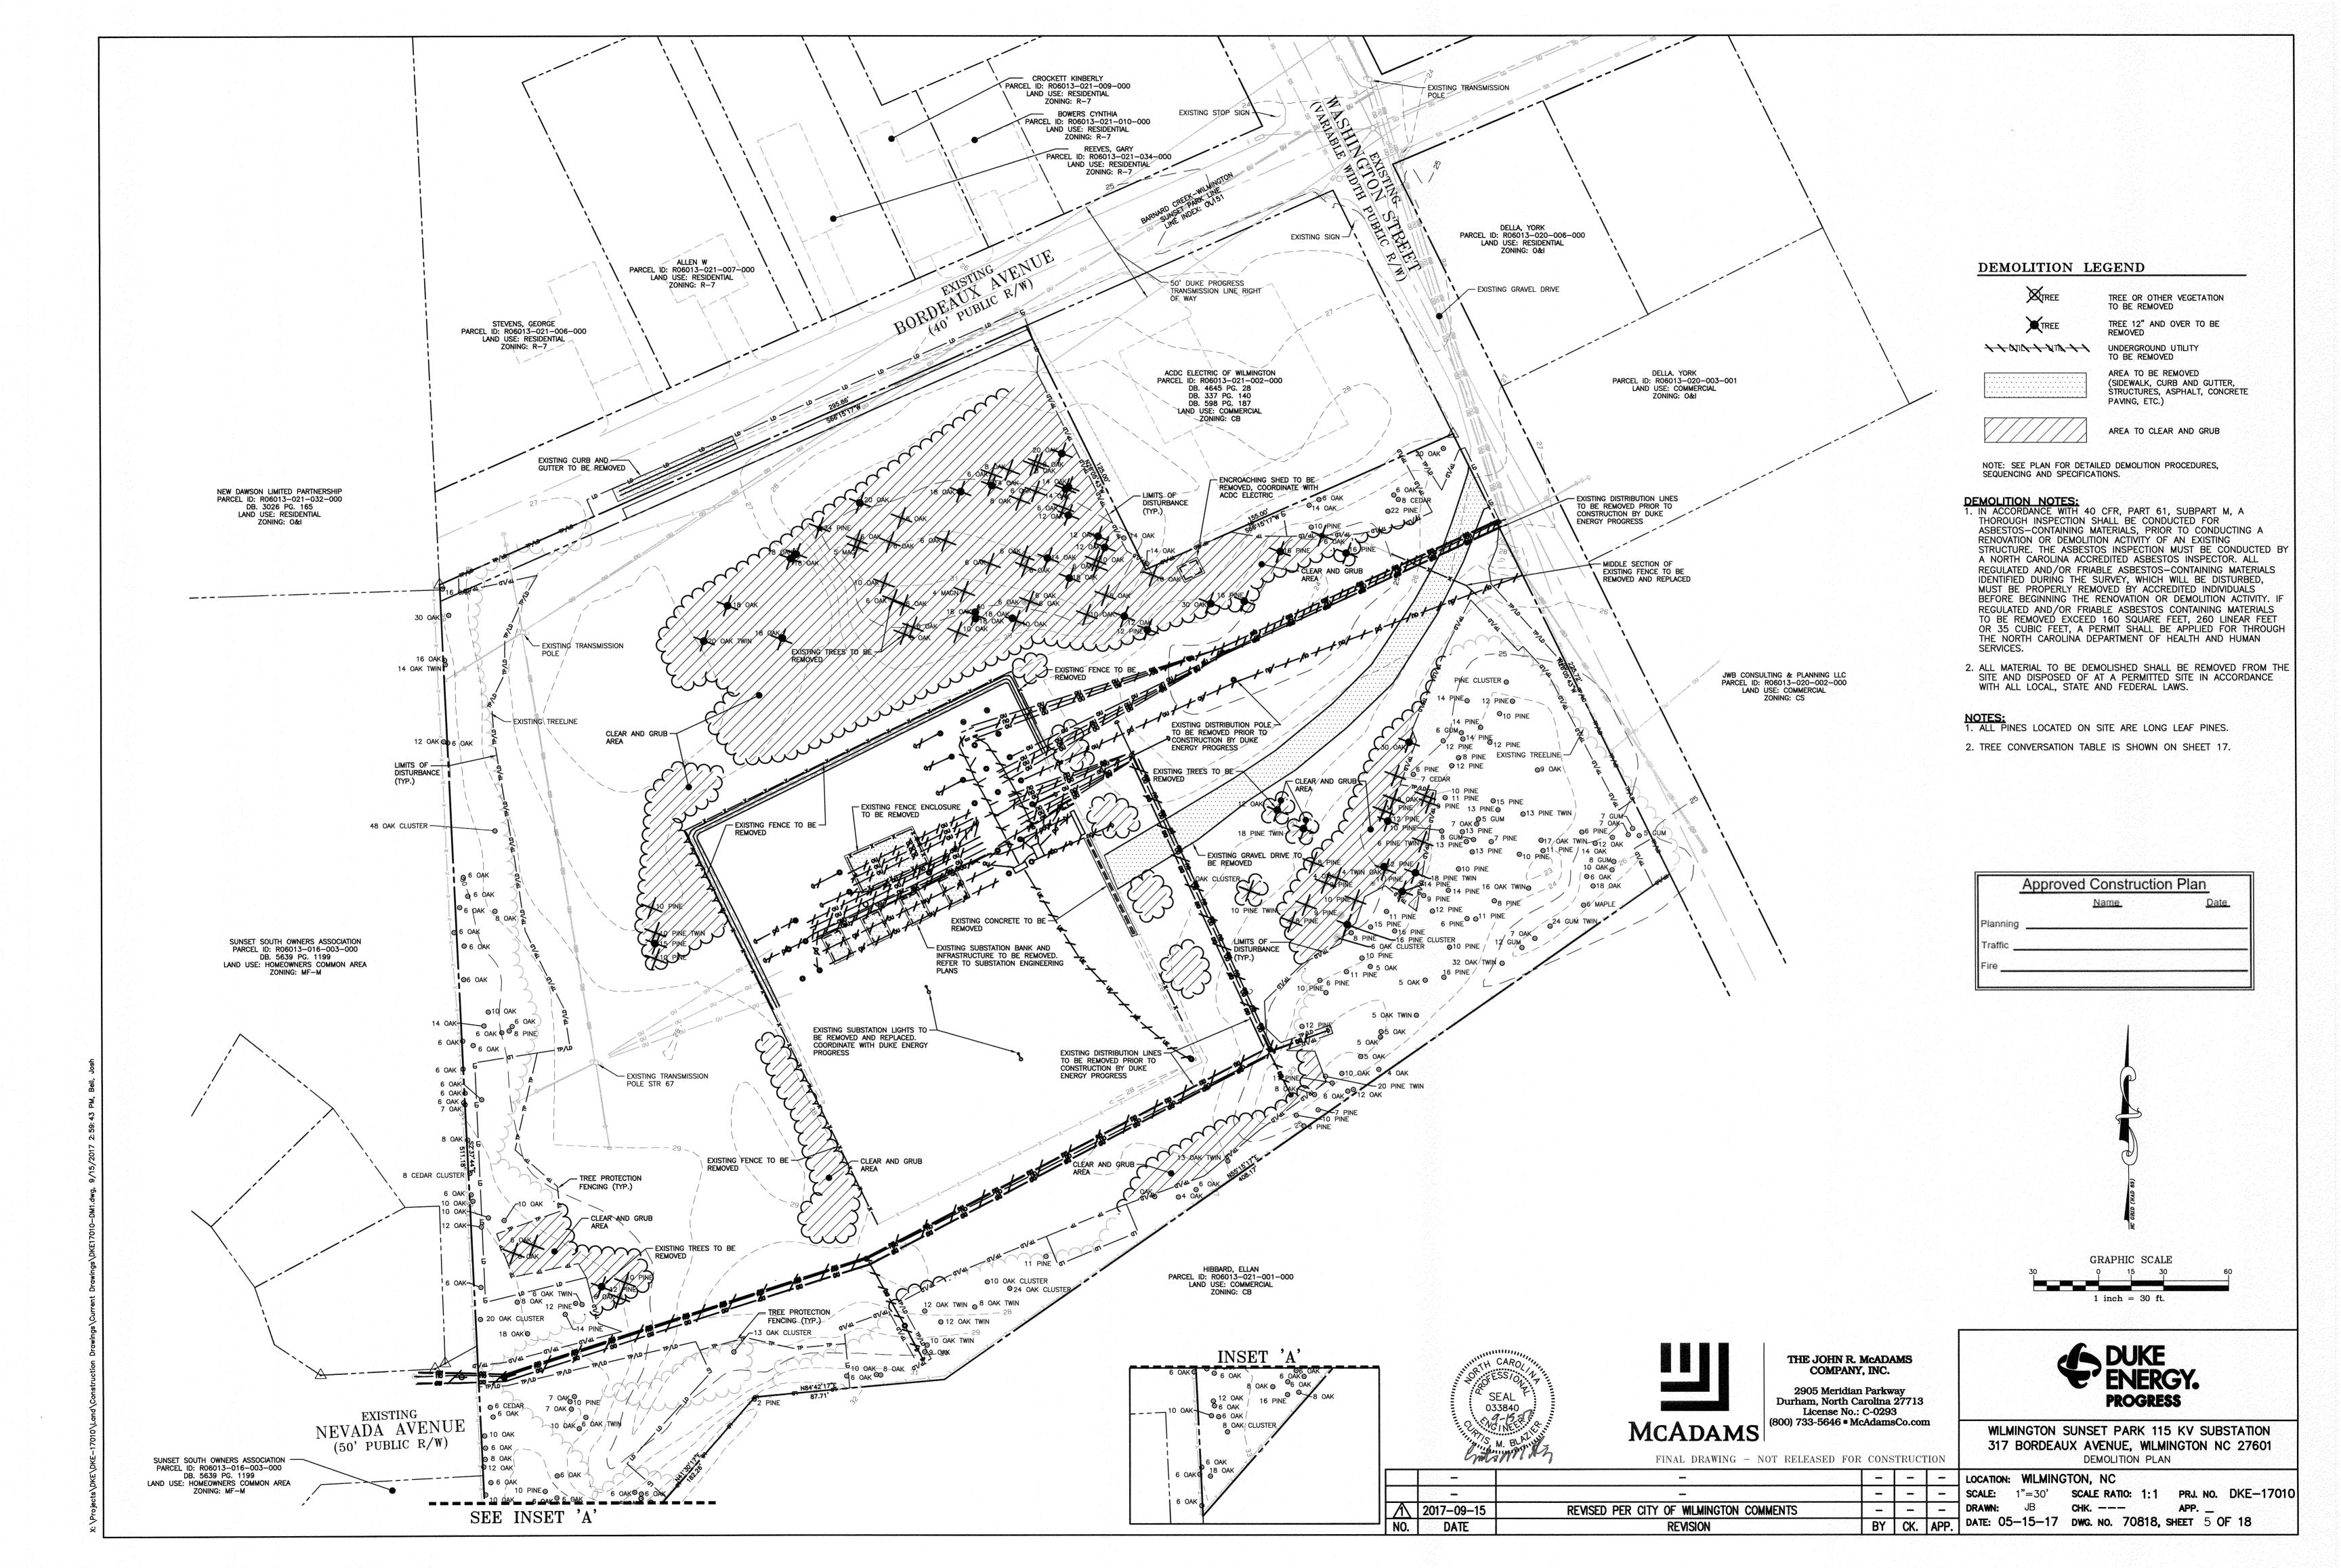


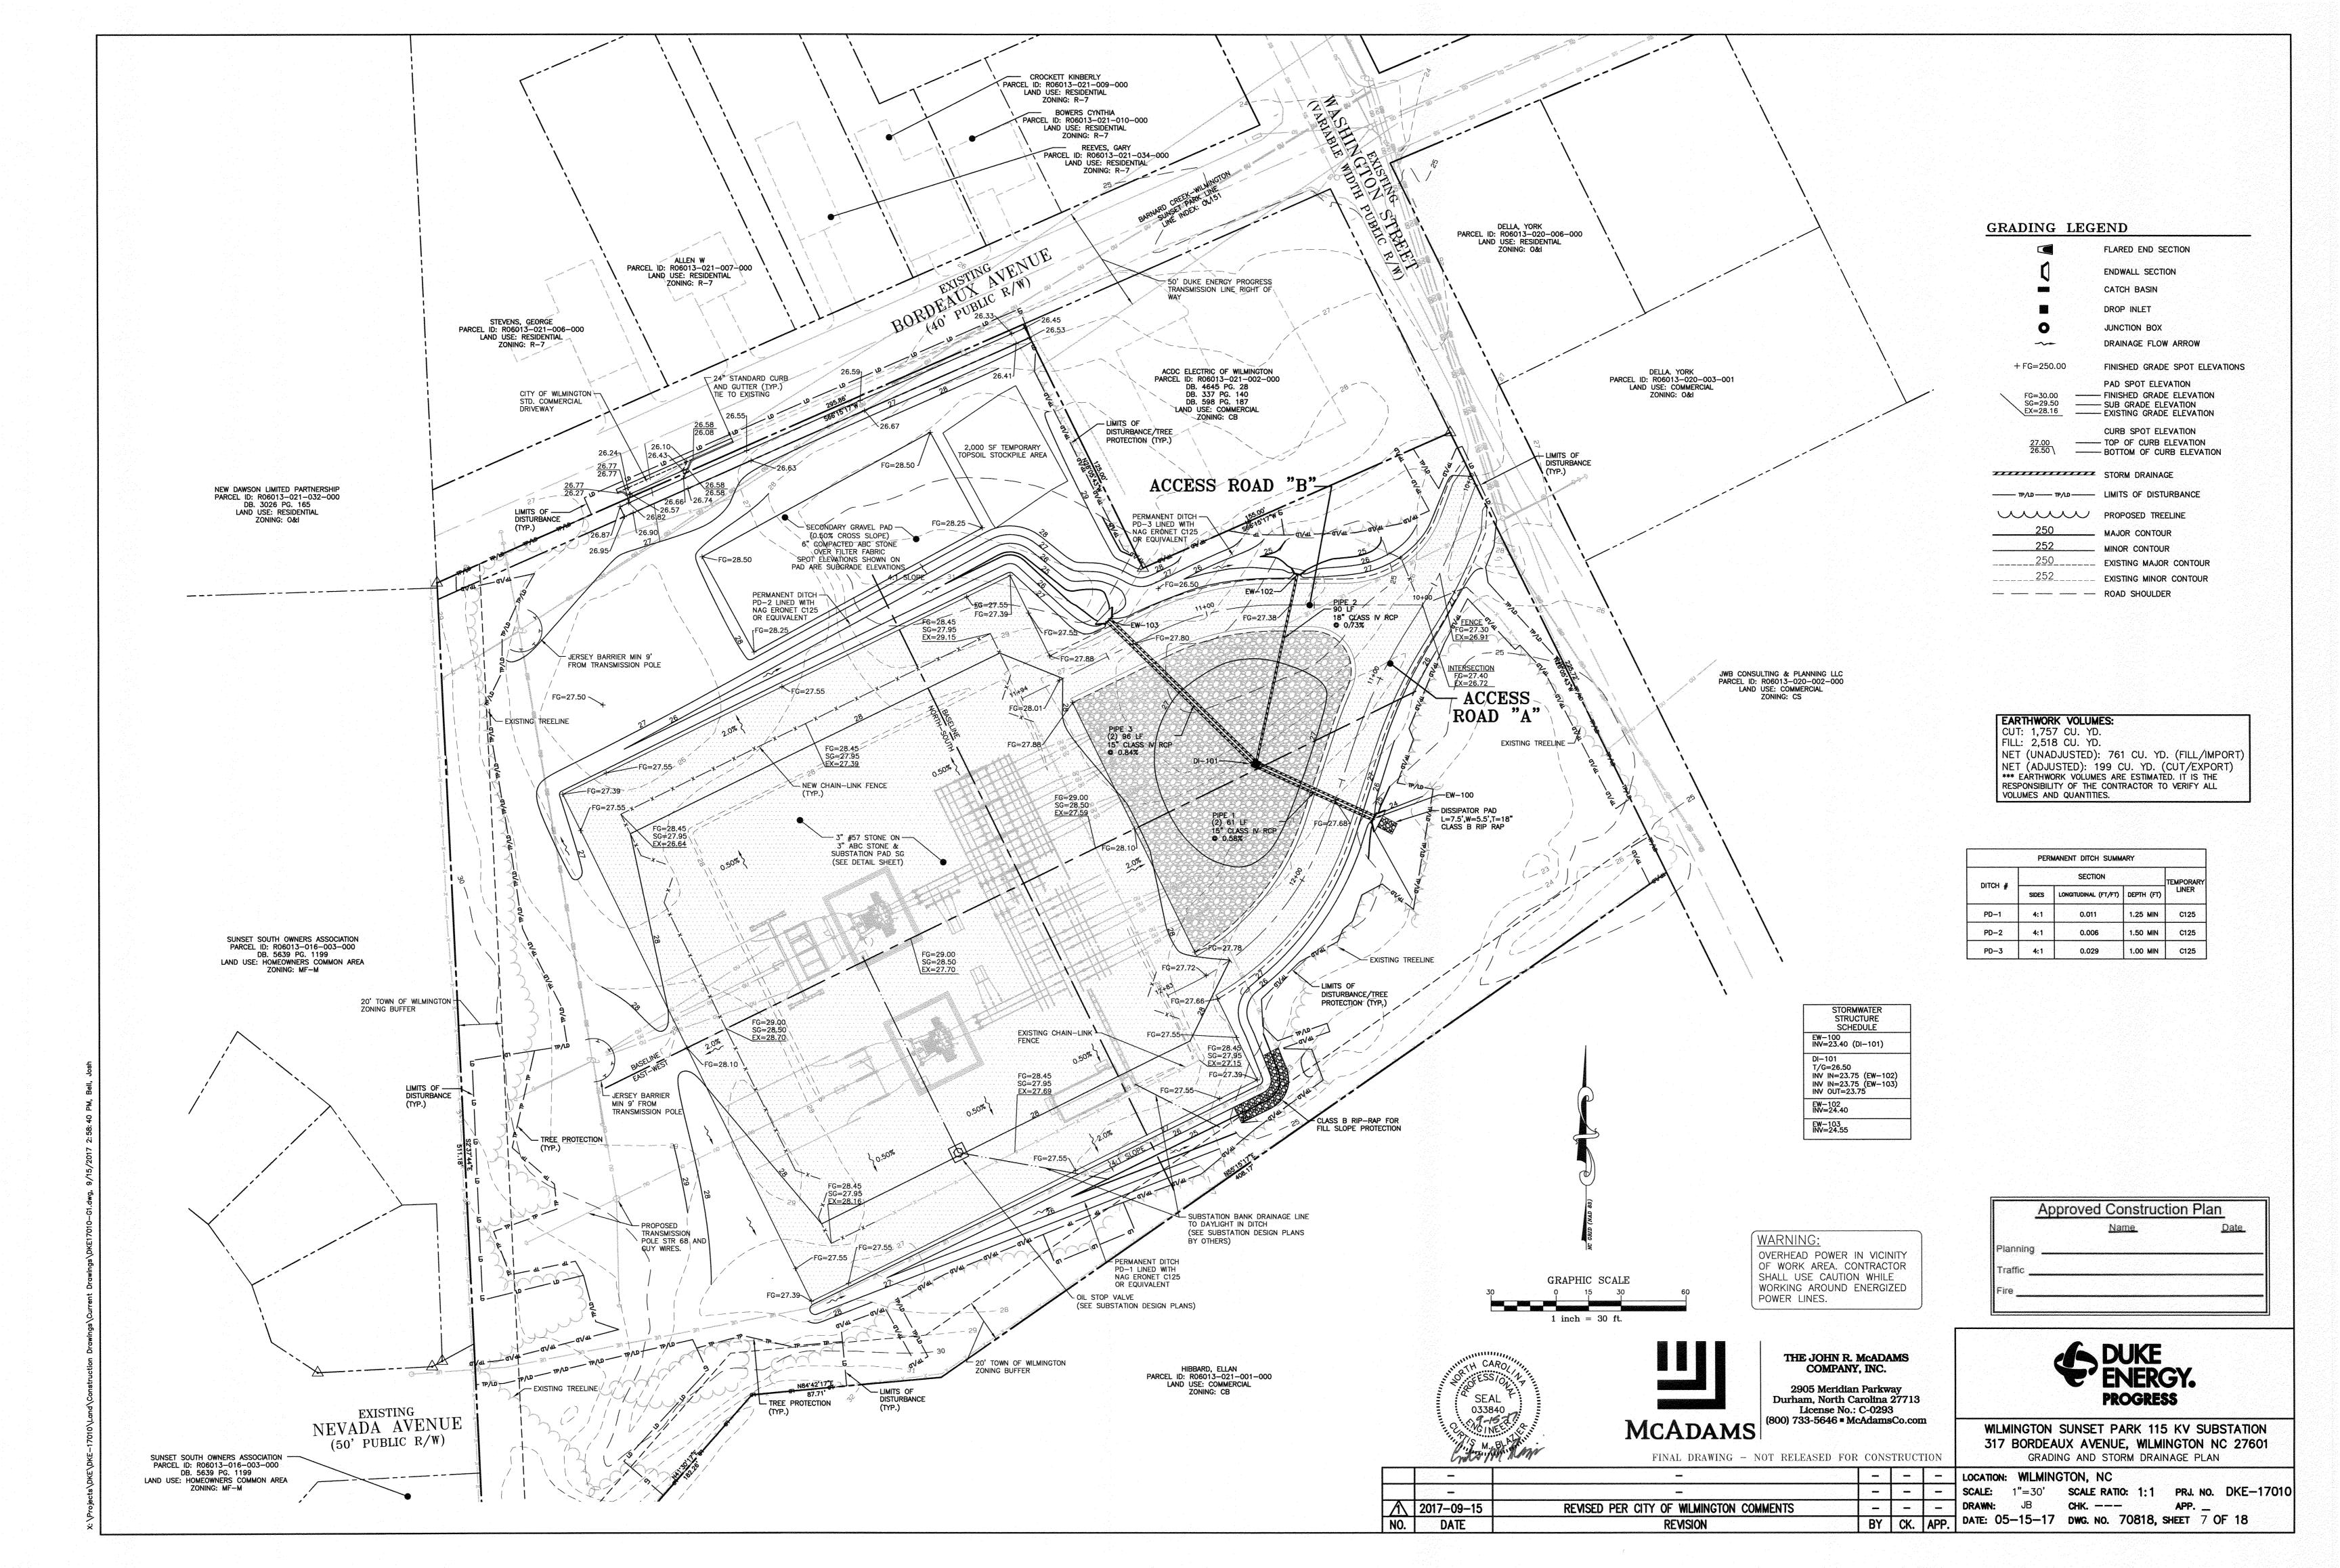


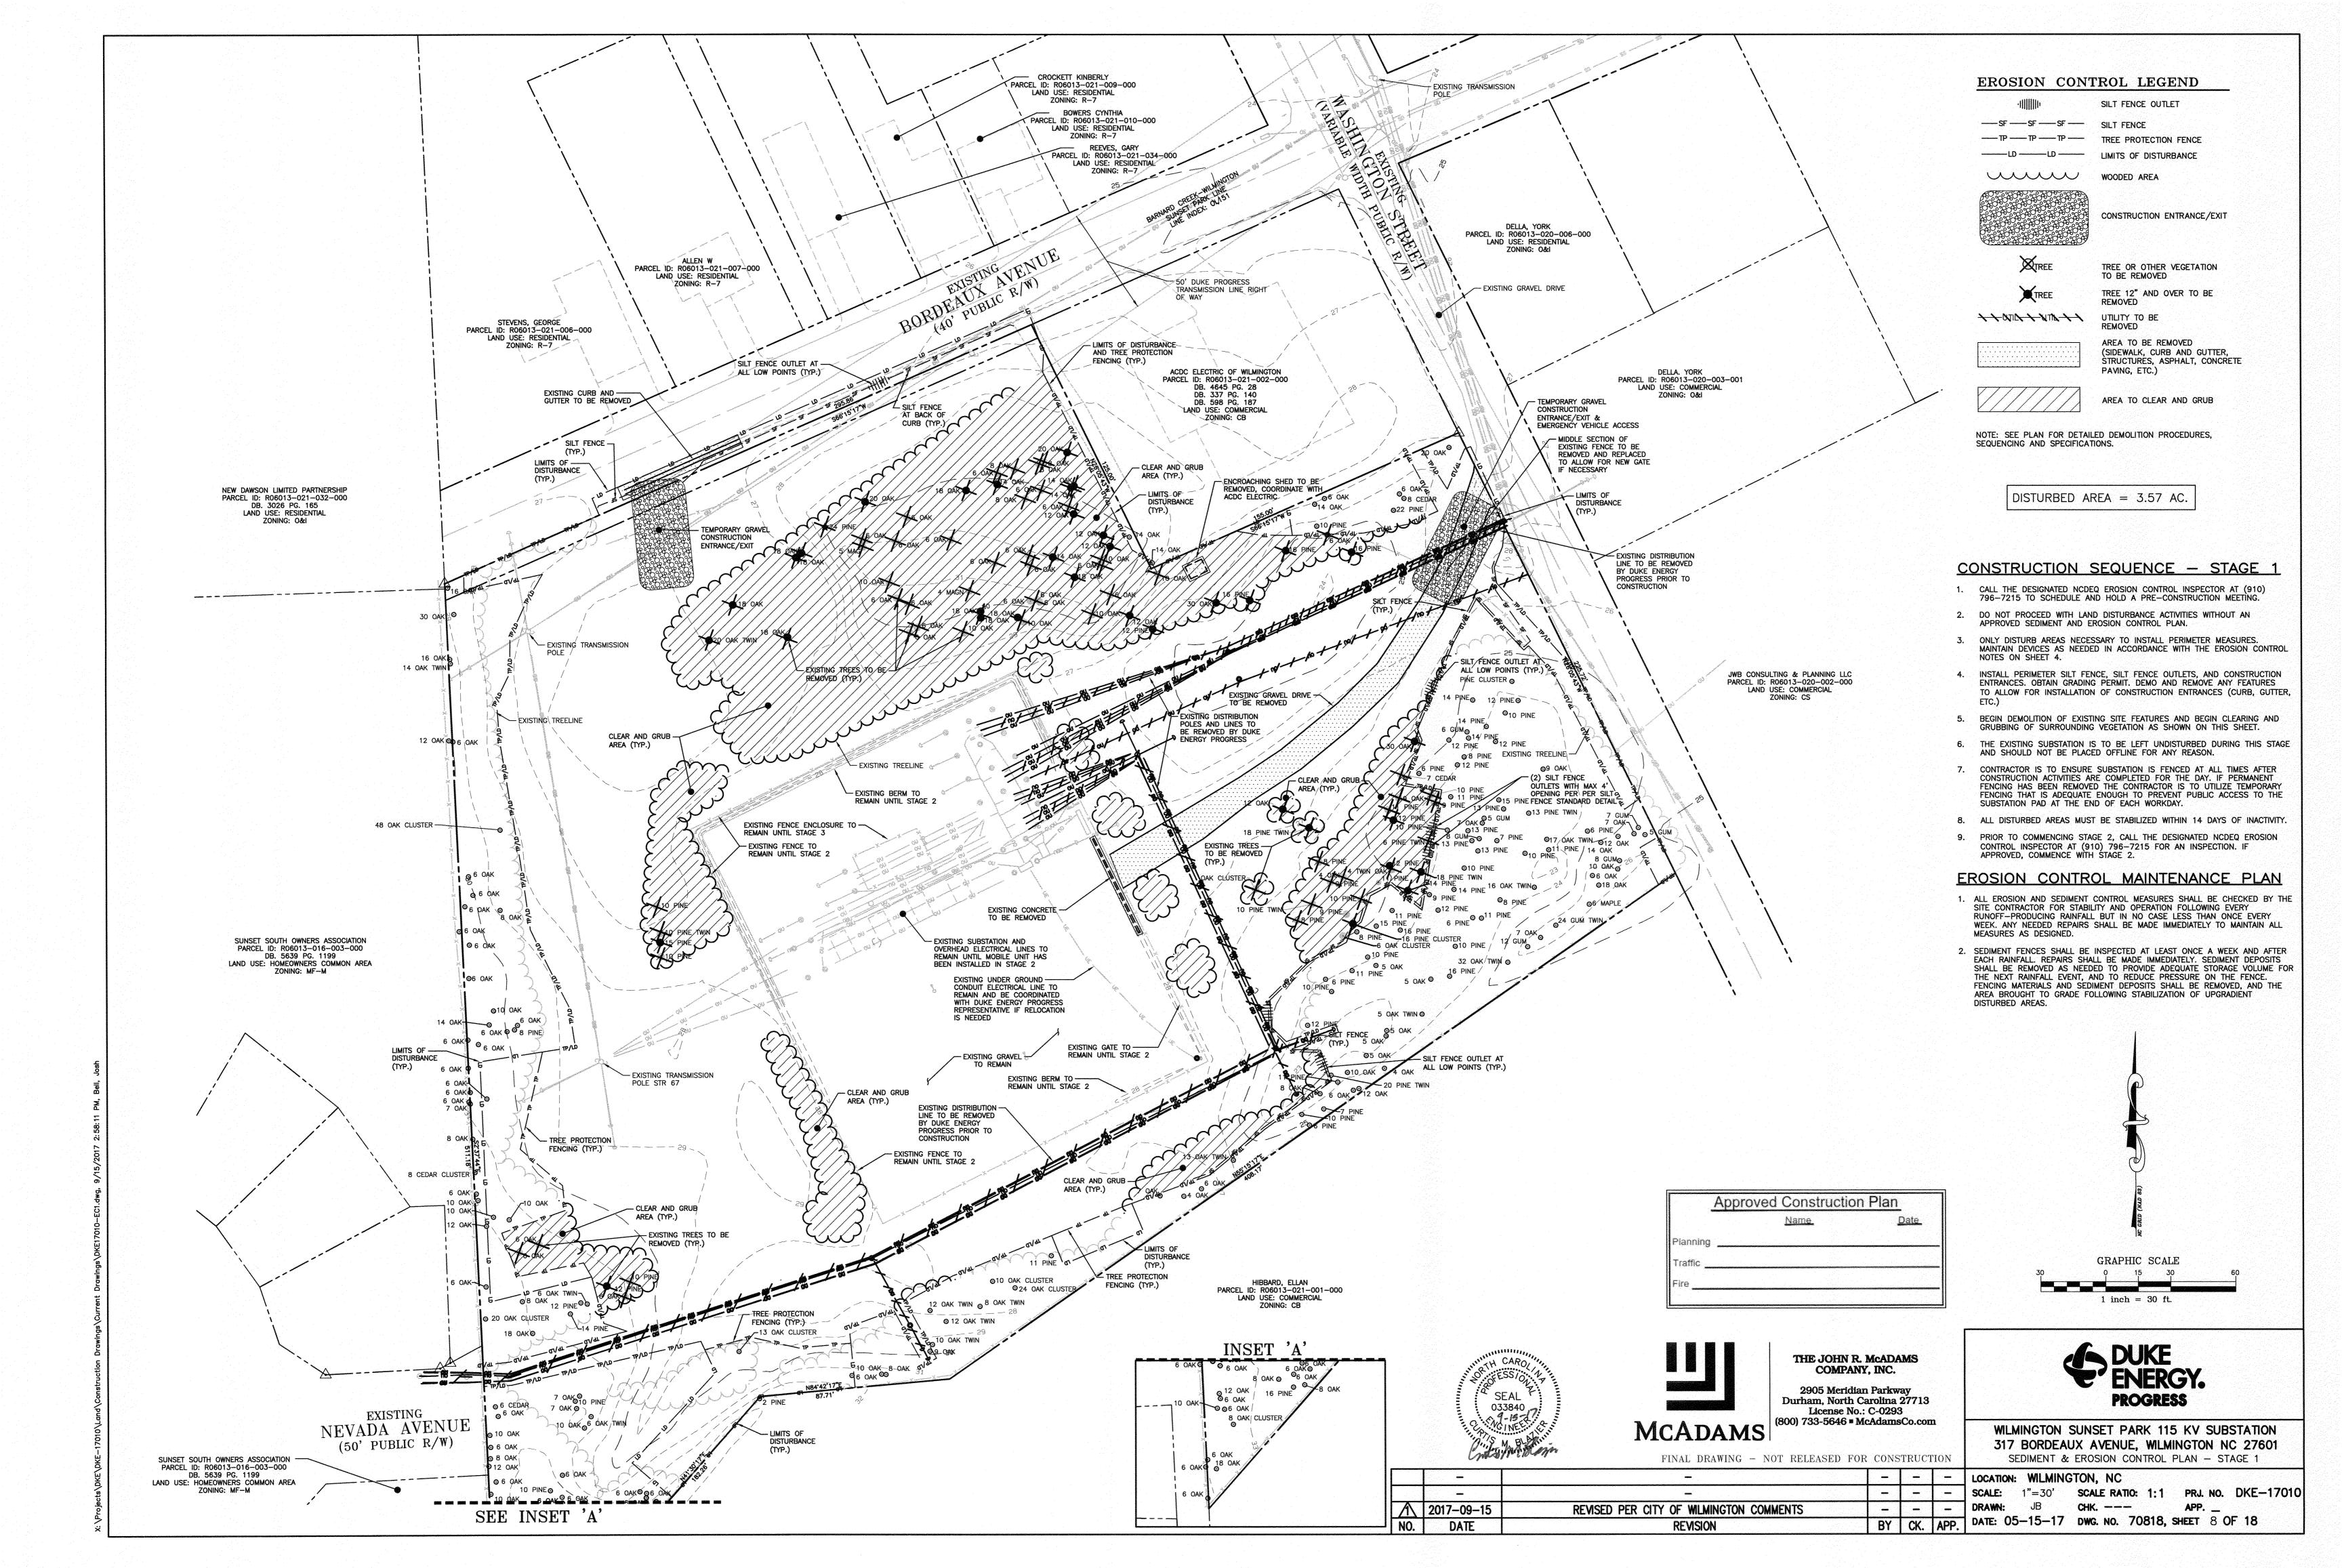


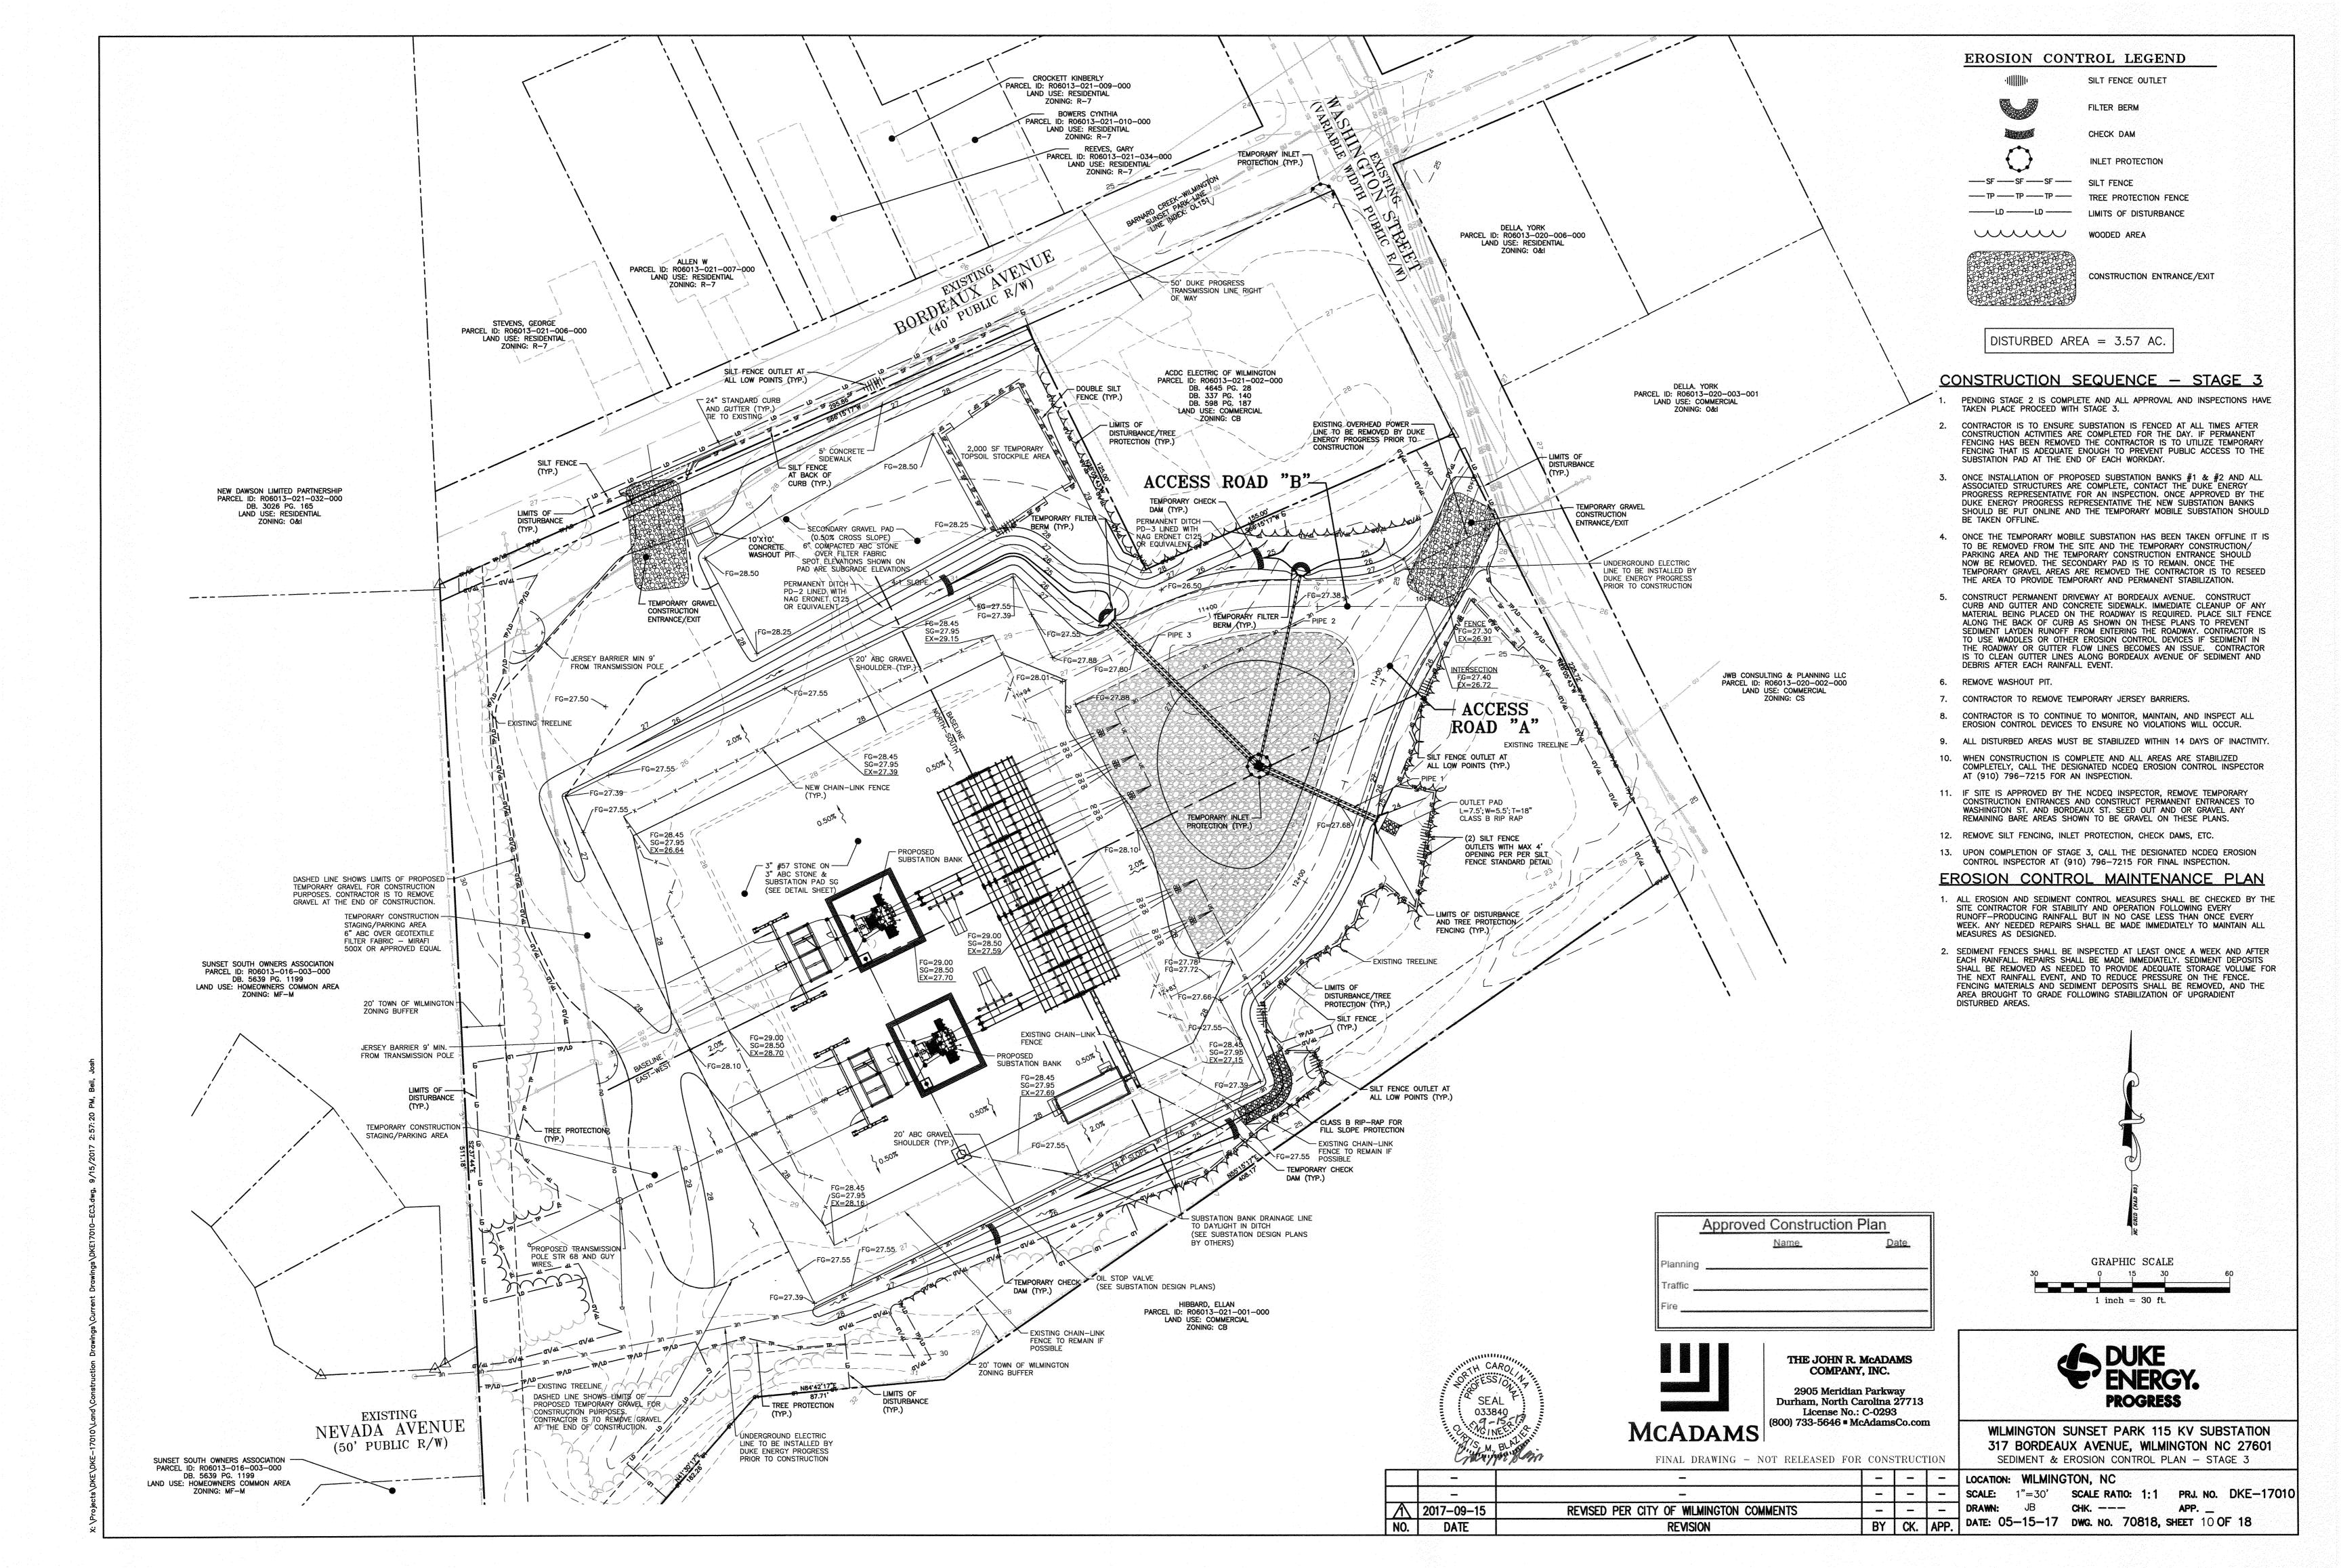


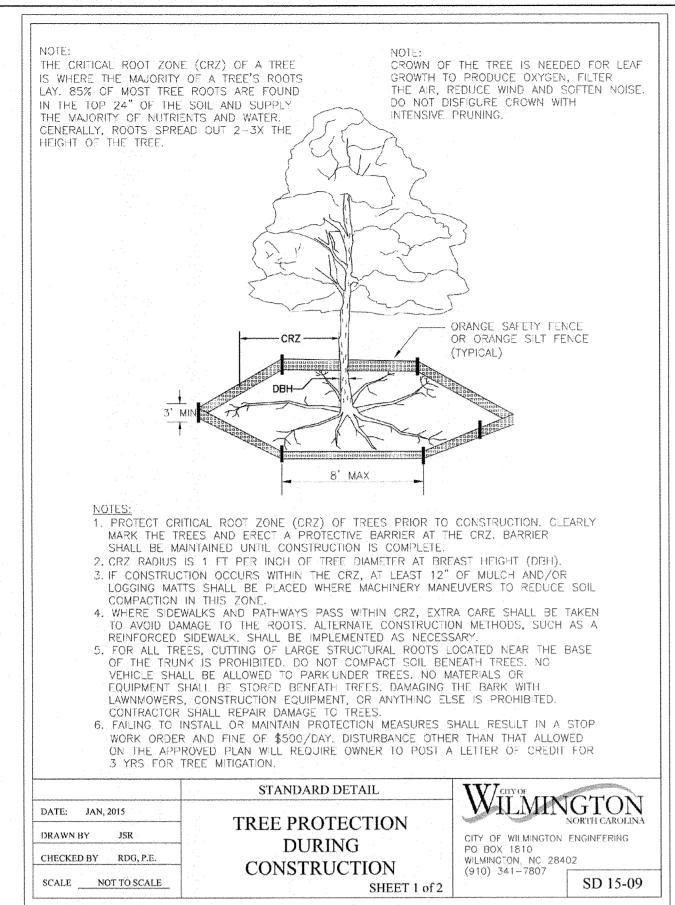


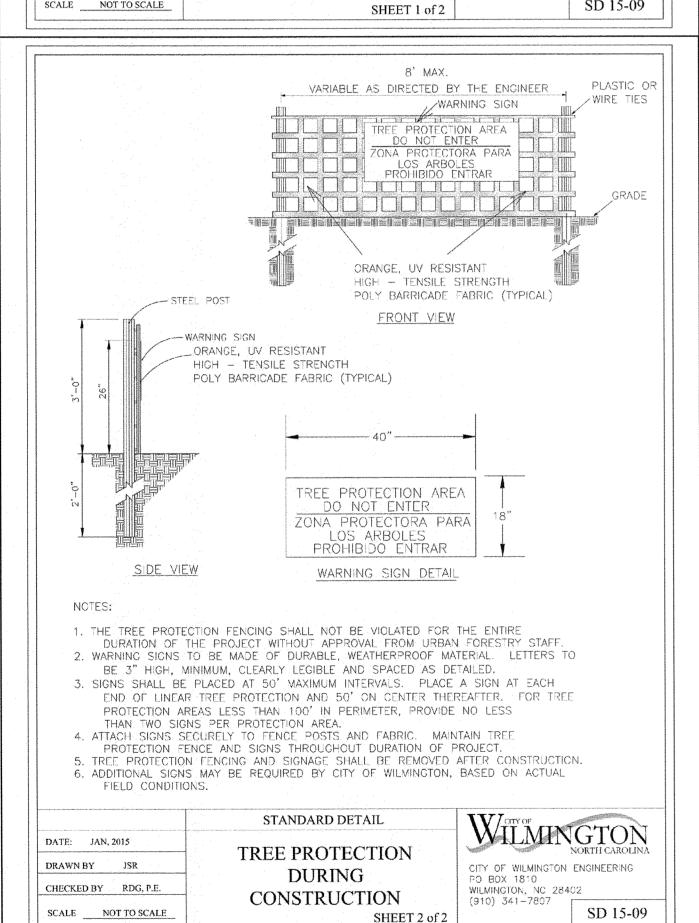


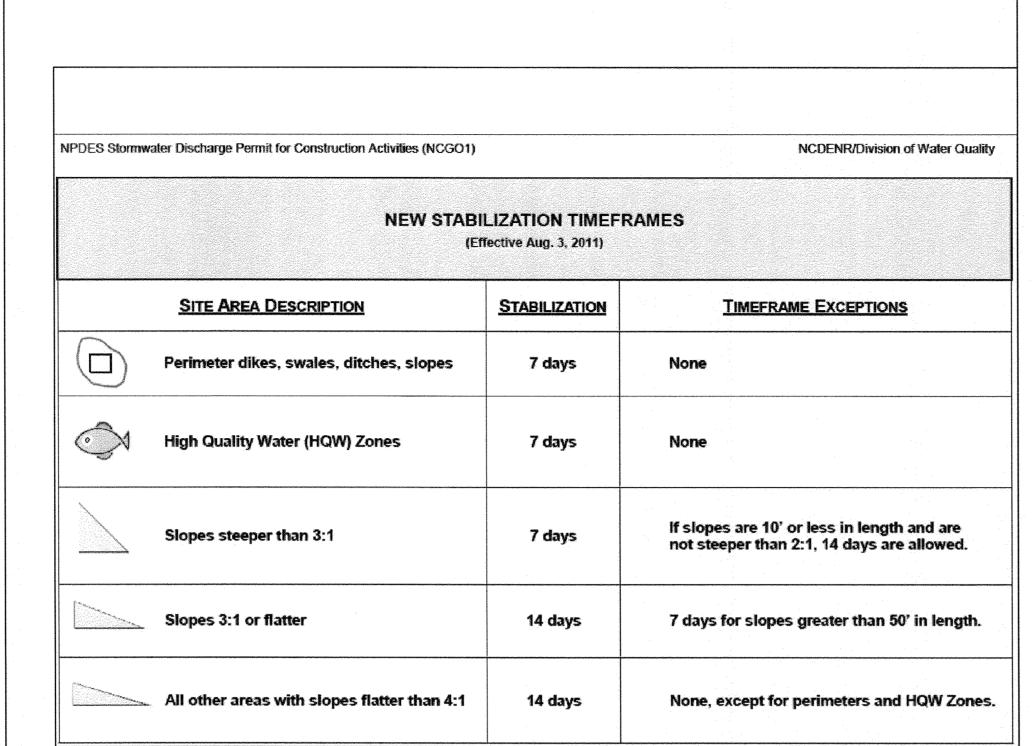


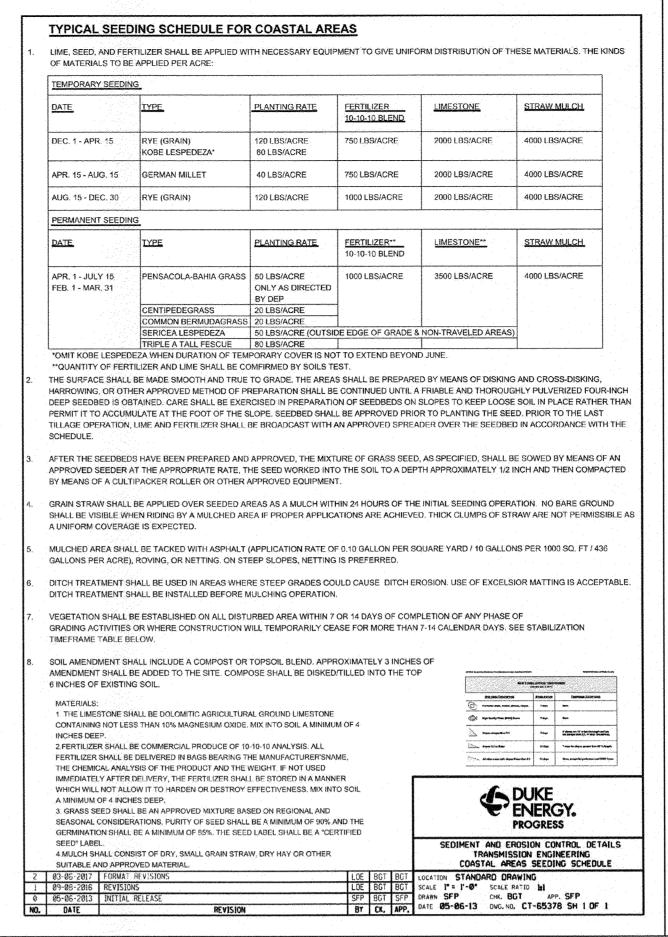

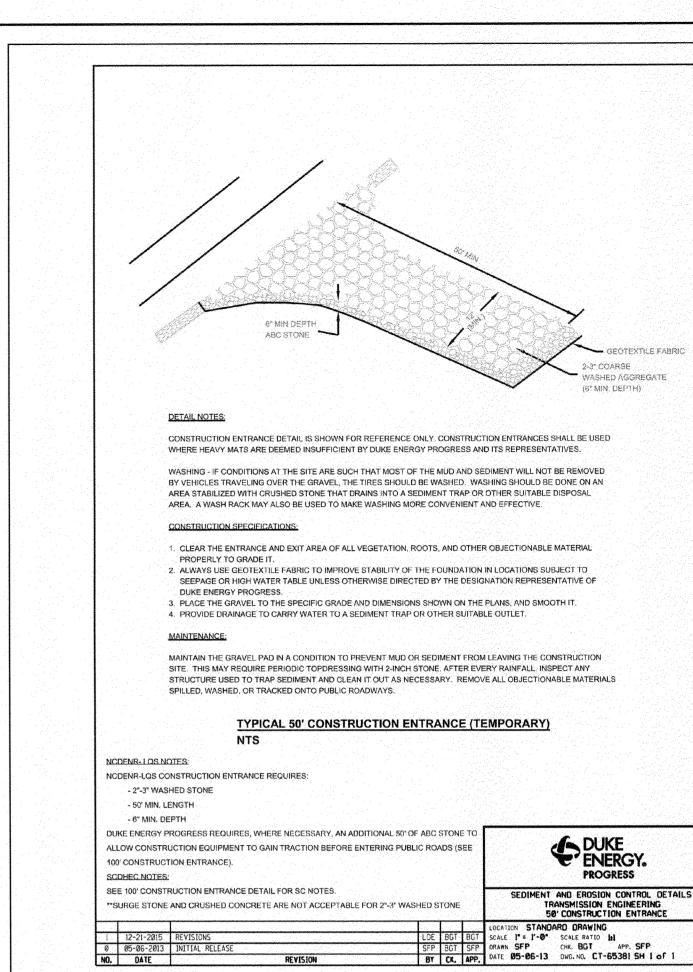

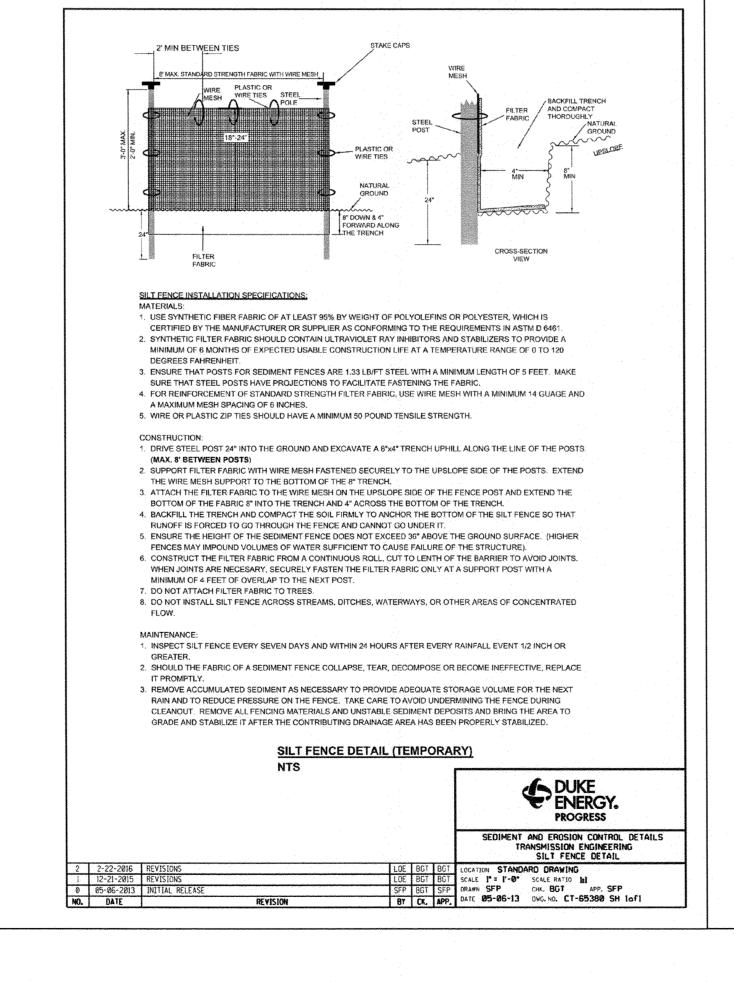


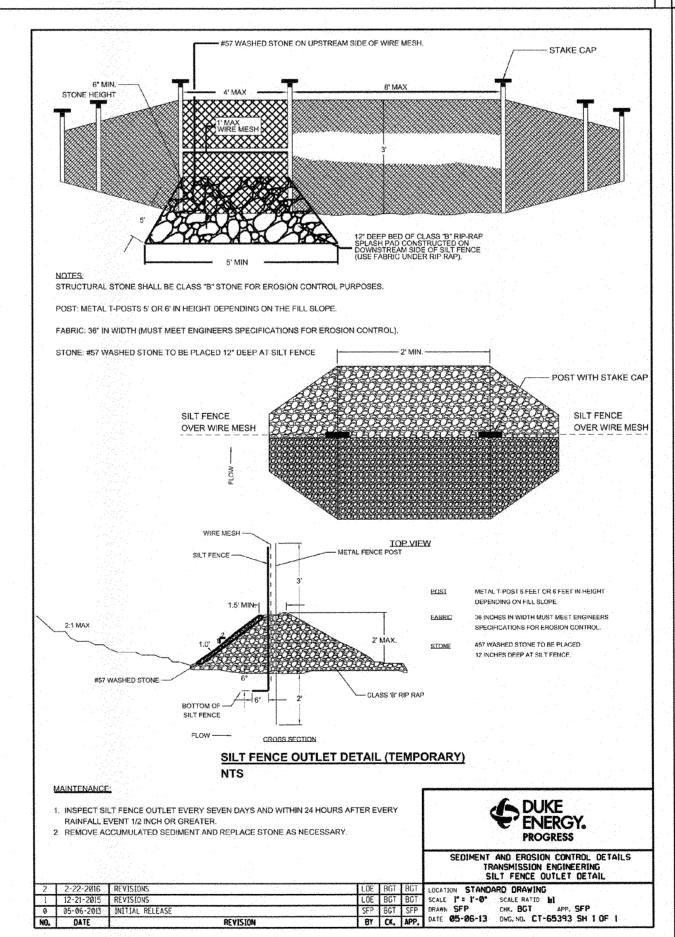

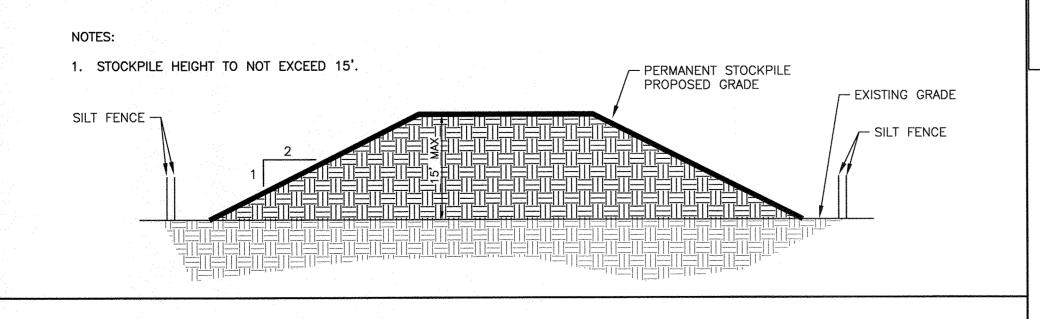

TYPICAL STOCKPILE DETAIL (NTS)

Approved Construction Plan 1 2017-09-NO.

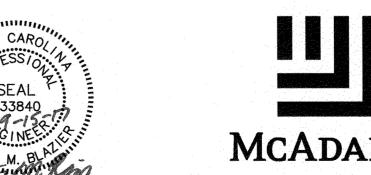

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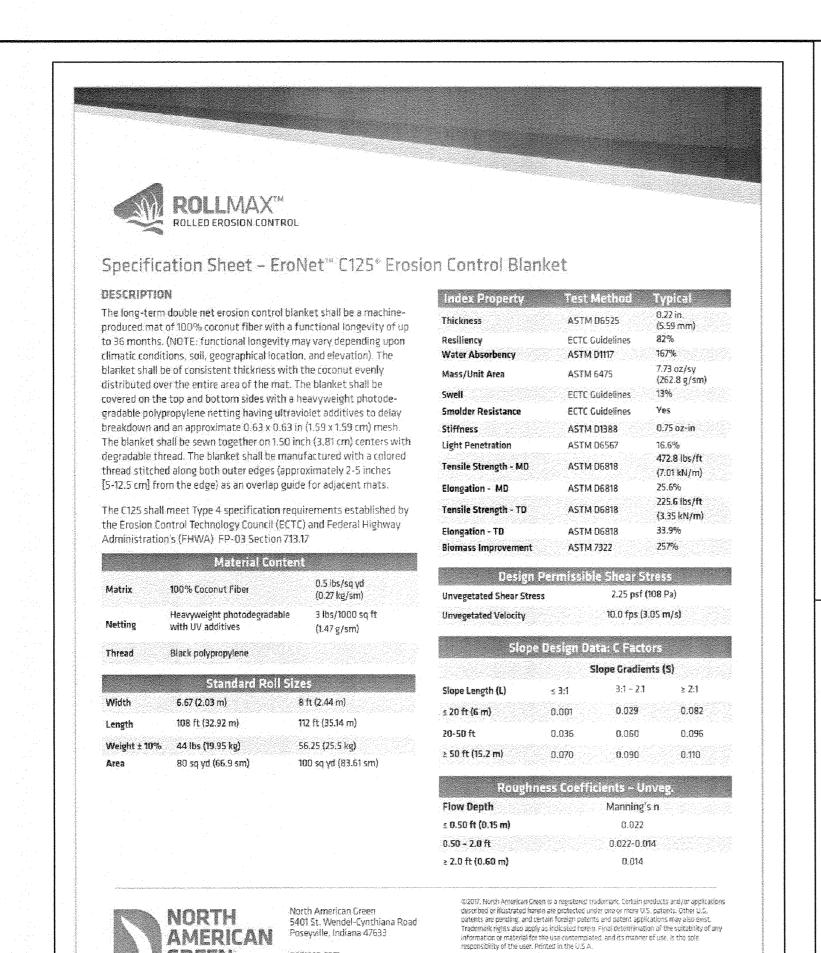
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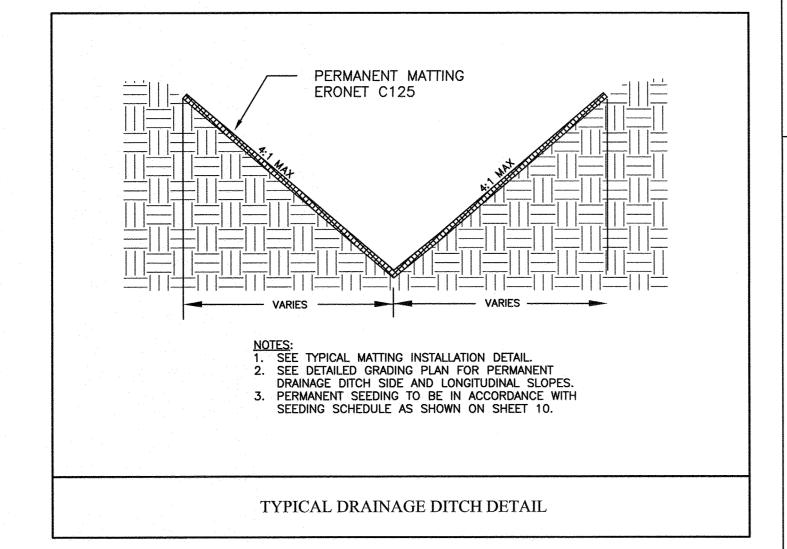


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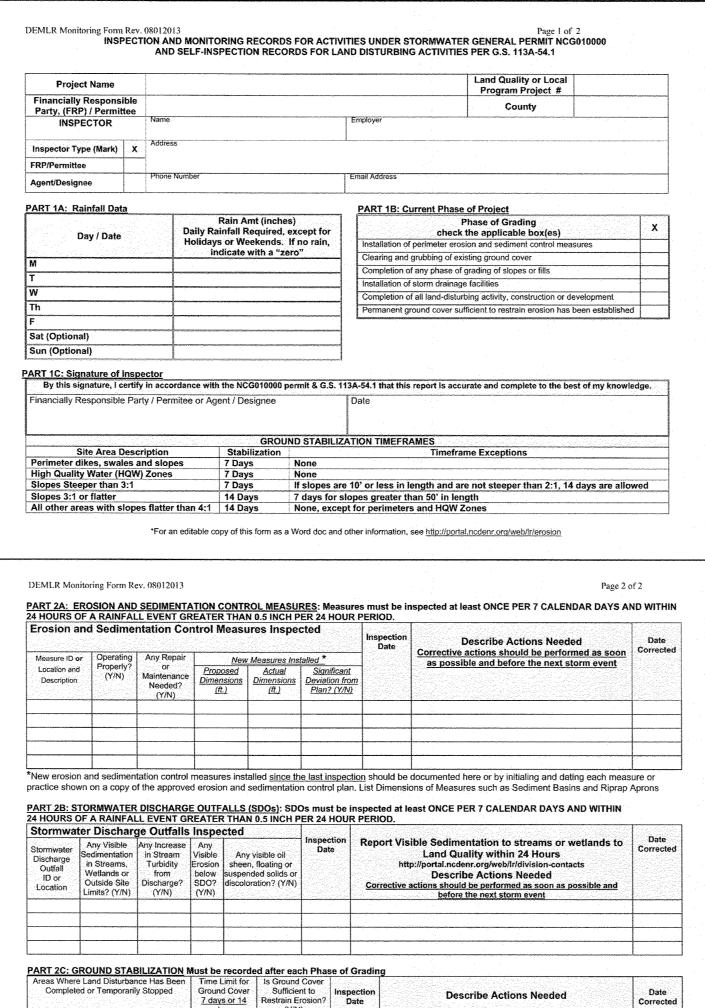
WILMINGTON SUNSET PARK 115 KV SUBSTATION 317 BORDEAUX AVENUE, WILMINGTON NC 27601

	FINAL DRAWING - NOT RELEAS	SED FOR CO	NSTRUC	HON	SEDIMENT & EROSION CONTROL DETAILS
				-	LOCATION: WILMINGTON, NC
				-	SCALE: NTS SCALE RATIO: 1:1 PRJ. NO. DKE-17010
-15	REVISED PER CITY OF WILMINGTON COMMENTS	-		-	DRAWN: JB CHK APP
	REVISION	В	Y CK.	APP.	DATE: 05-15-17 DWG. NO. 70818, SHEET 11 OF 18







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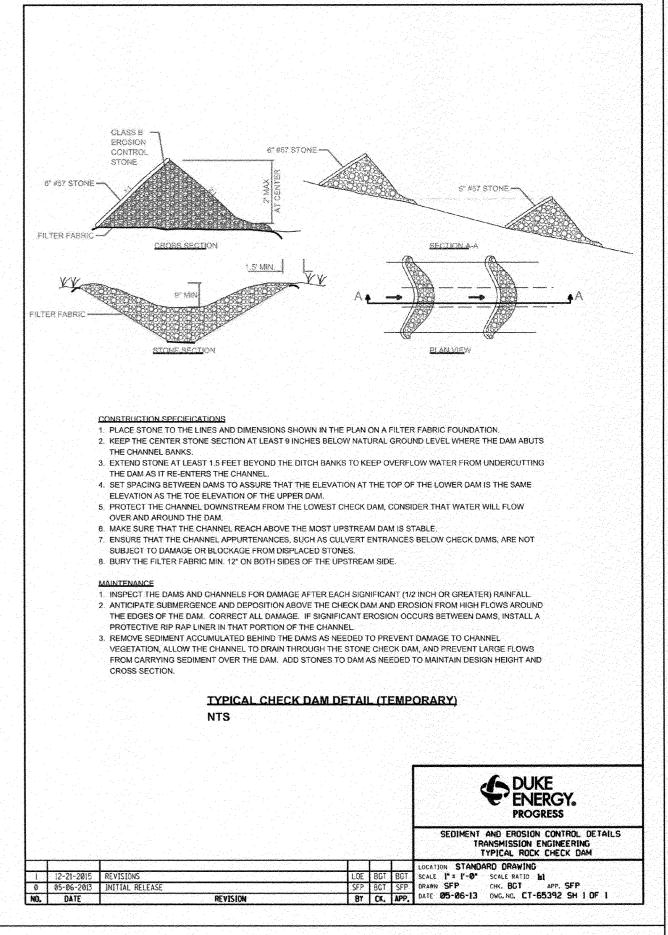



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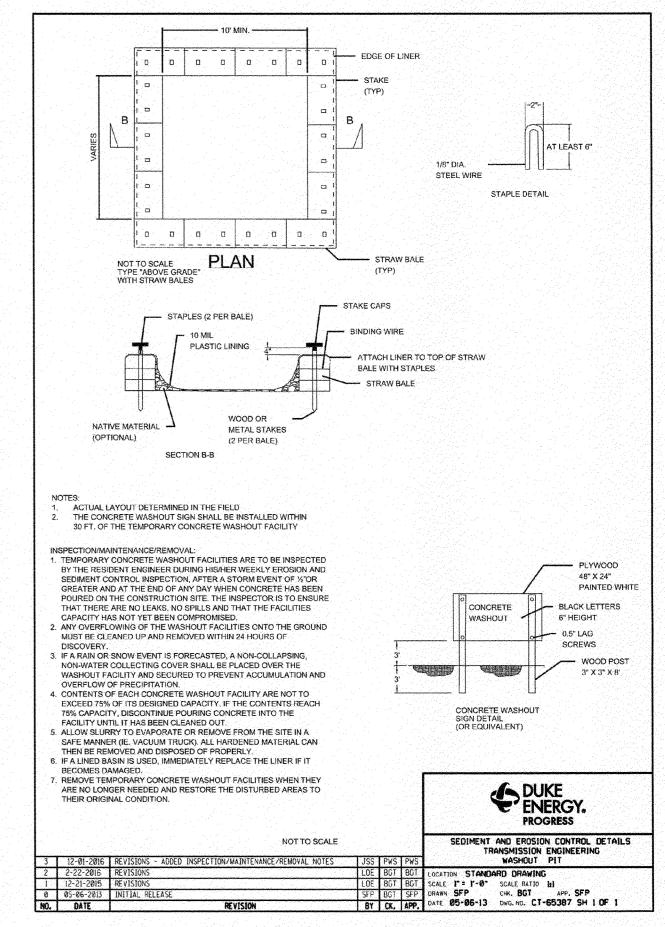



Approved Construction Plan

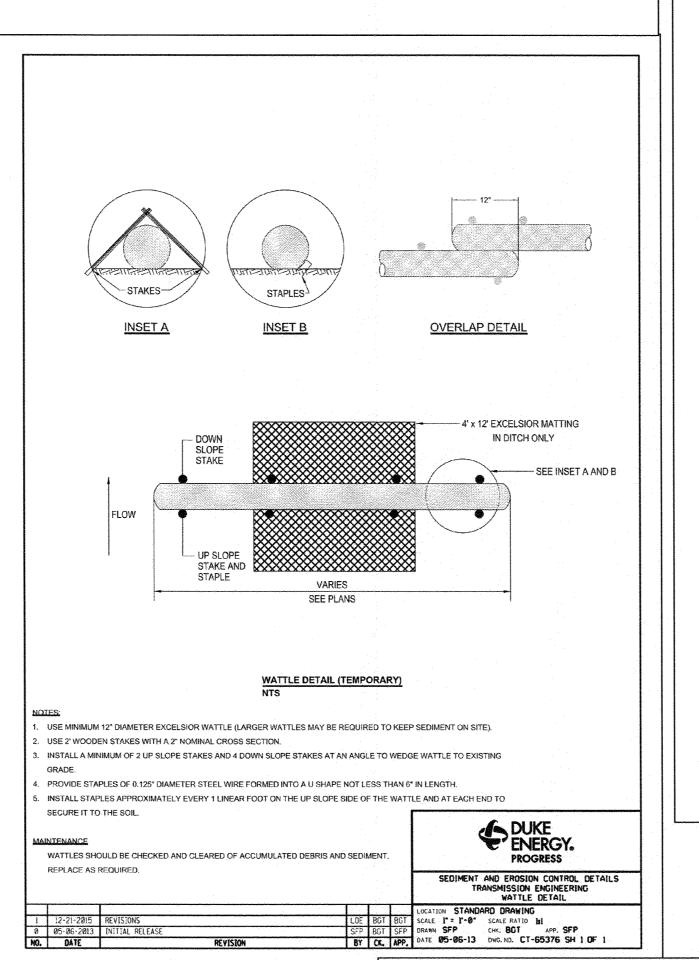



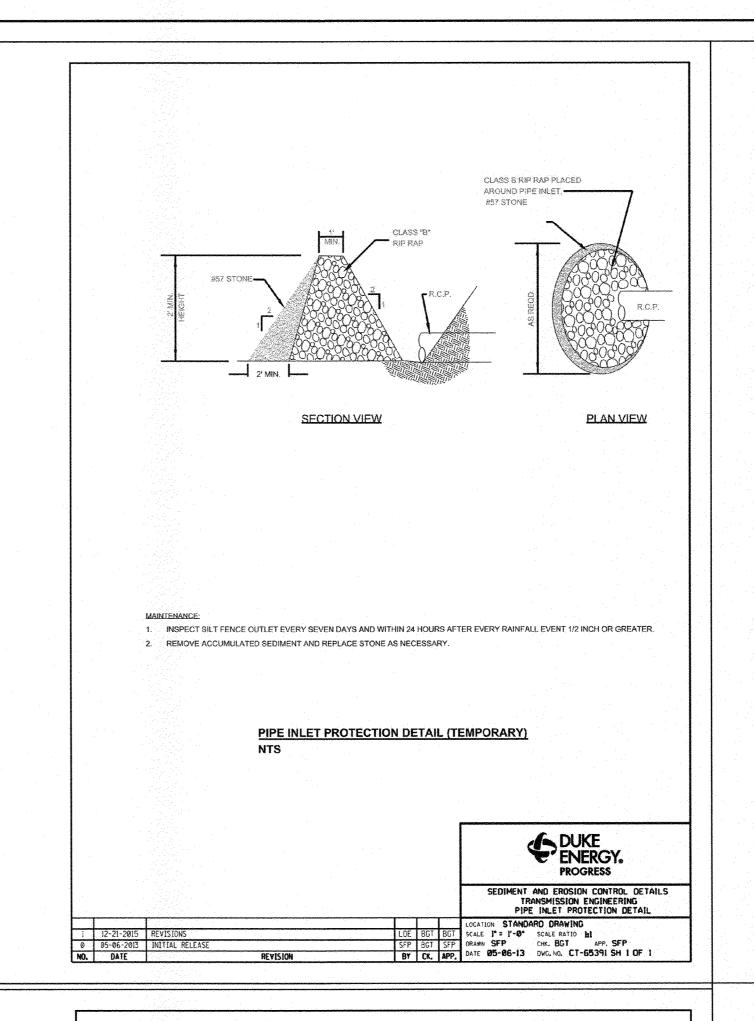

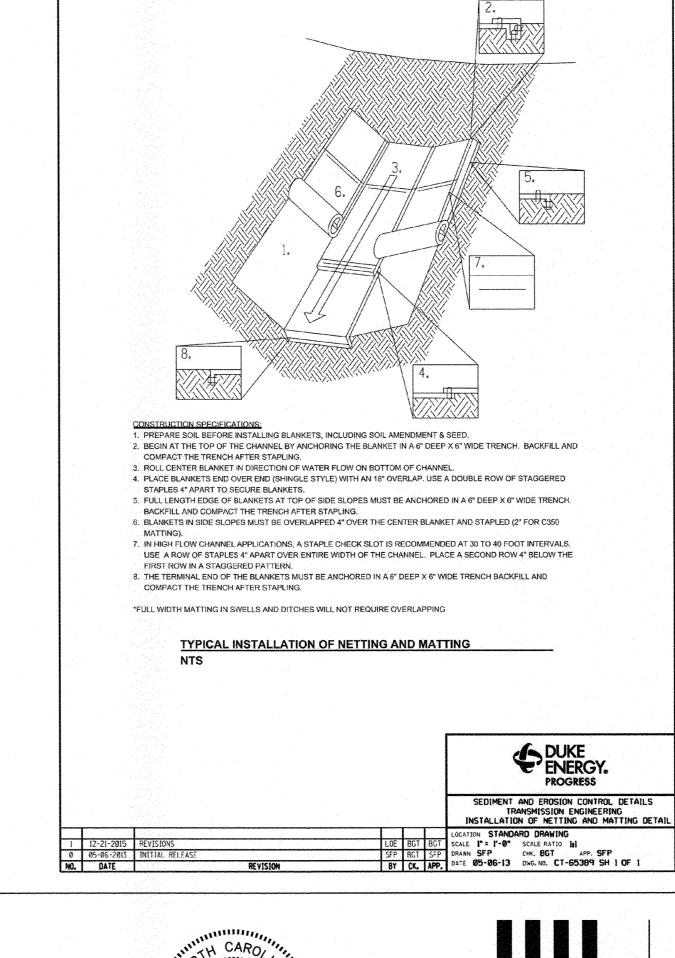

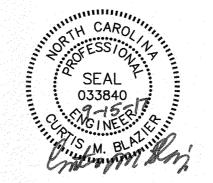

1 2017-09-15

DATE



REVISED PER CITY OF WILMINGTON COMMENTS

REVISION

THE JOHN R. McADAMS COMPANY, INC.


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WILMINGTON SUNSET PARK 115 KV SUBSTATION 317 BORDEAUX AVENUE, WILMINGTON NC 27601

LOCATION: WILMINGTON, NC

SCALE RATIO: 1:1 PRJ. NO. DKE-17010 CHK. ---DATE: 05-15-17 DWG. NO. 70818, SHEET 12 OF 18





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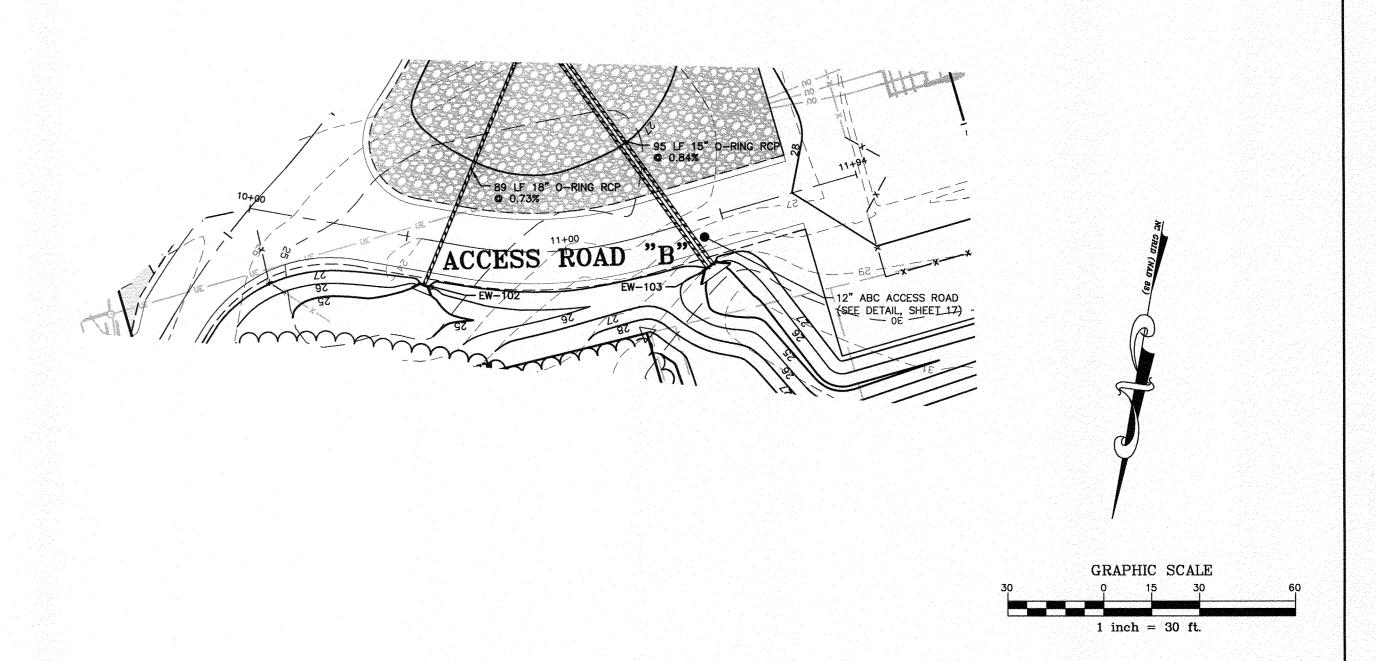
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SEDIMENT & EROSION CONTROL DETAILS

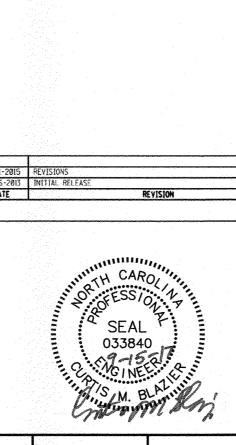
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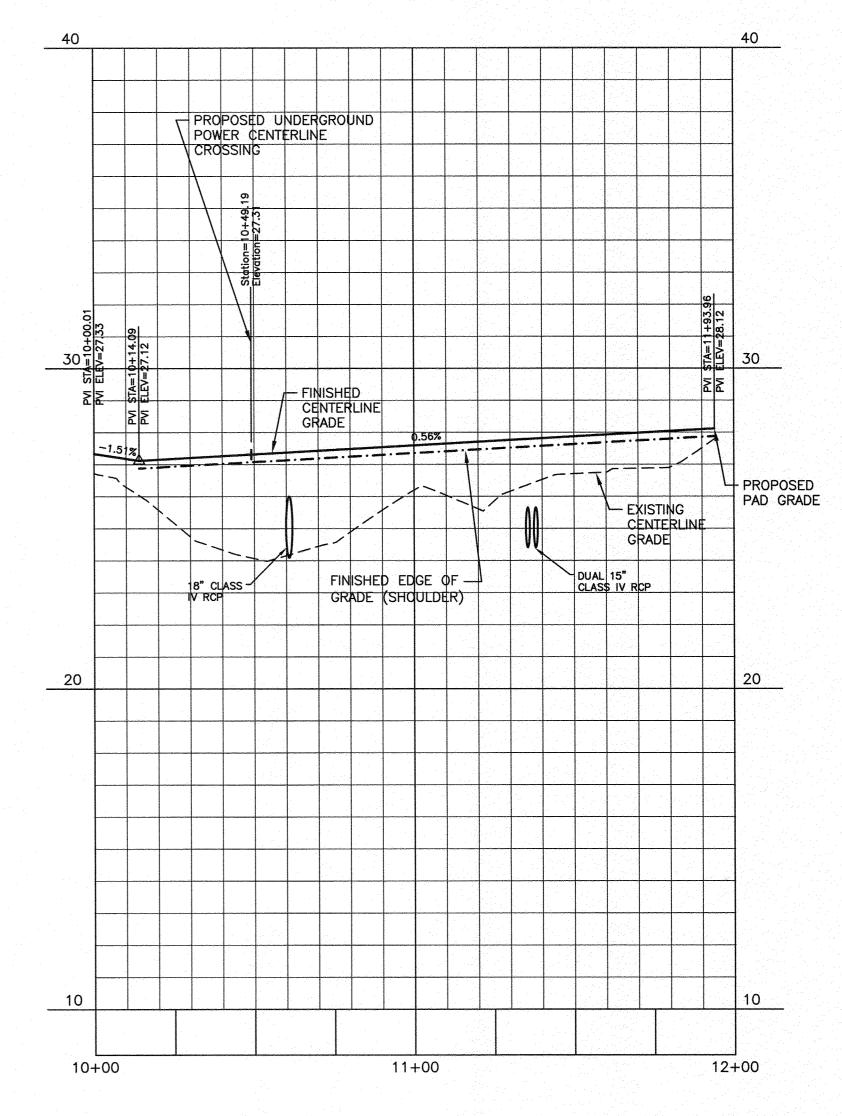


ACCESS ROAD "A"

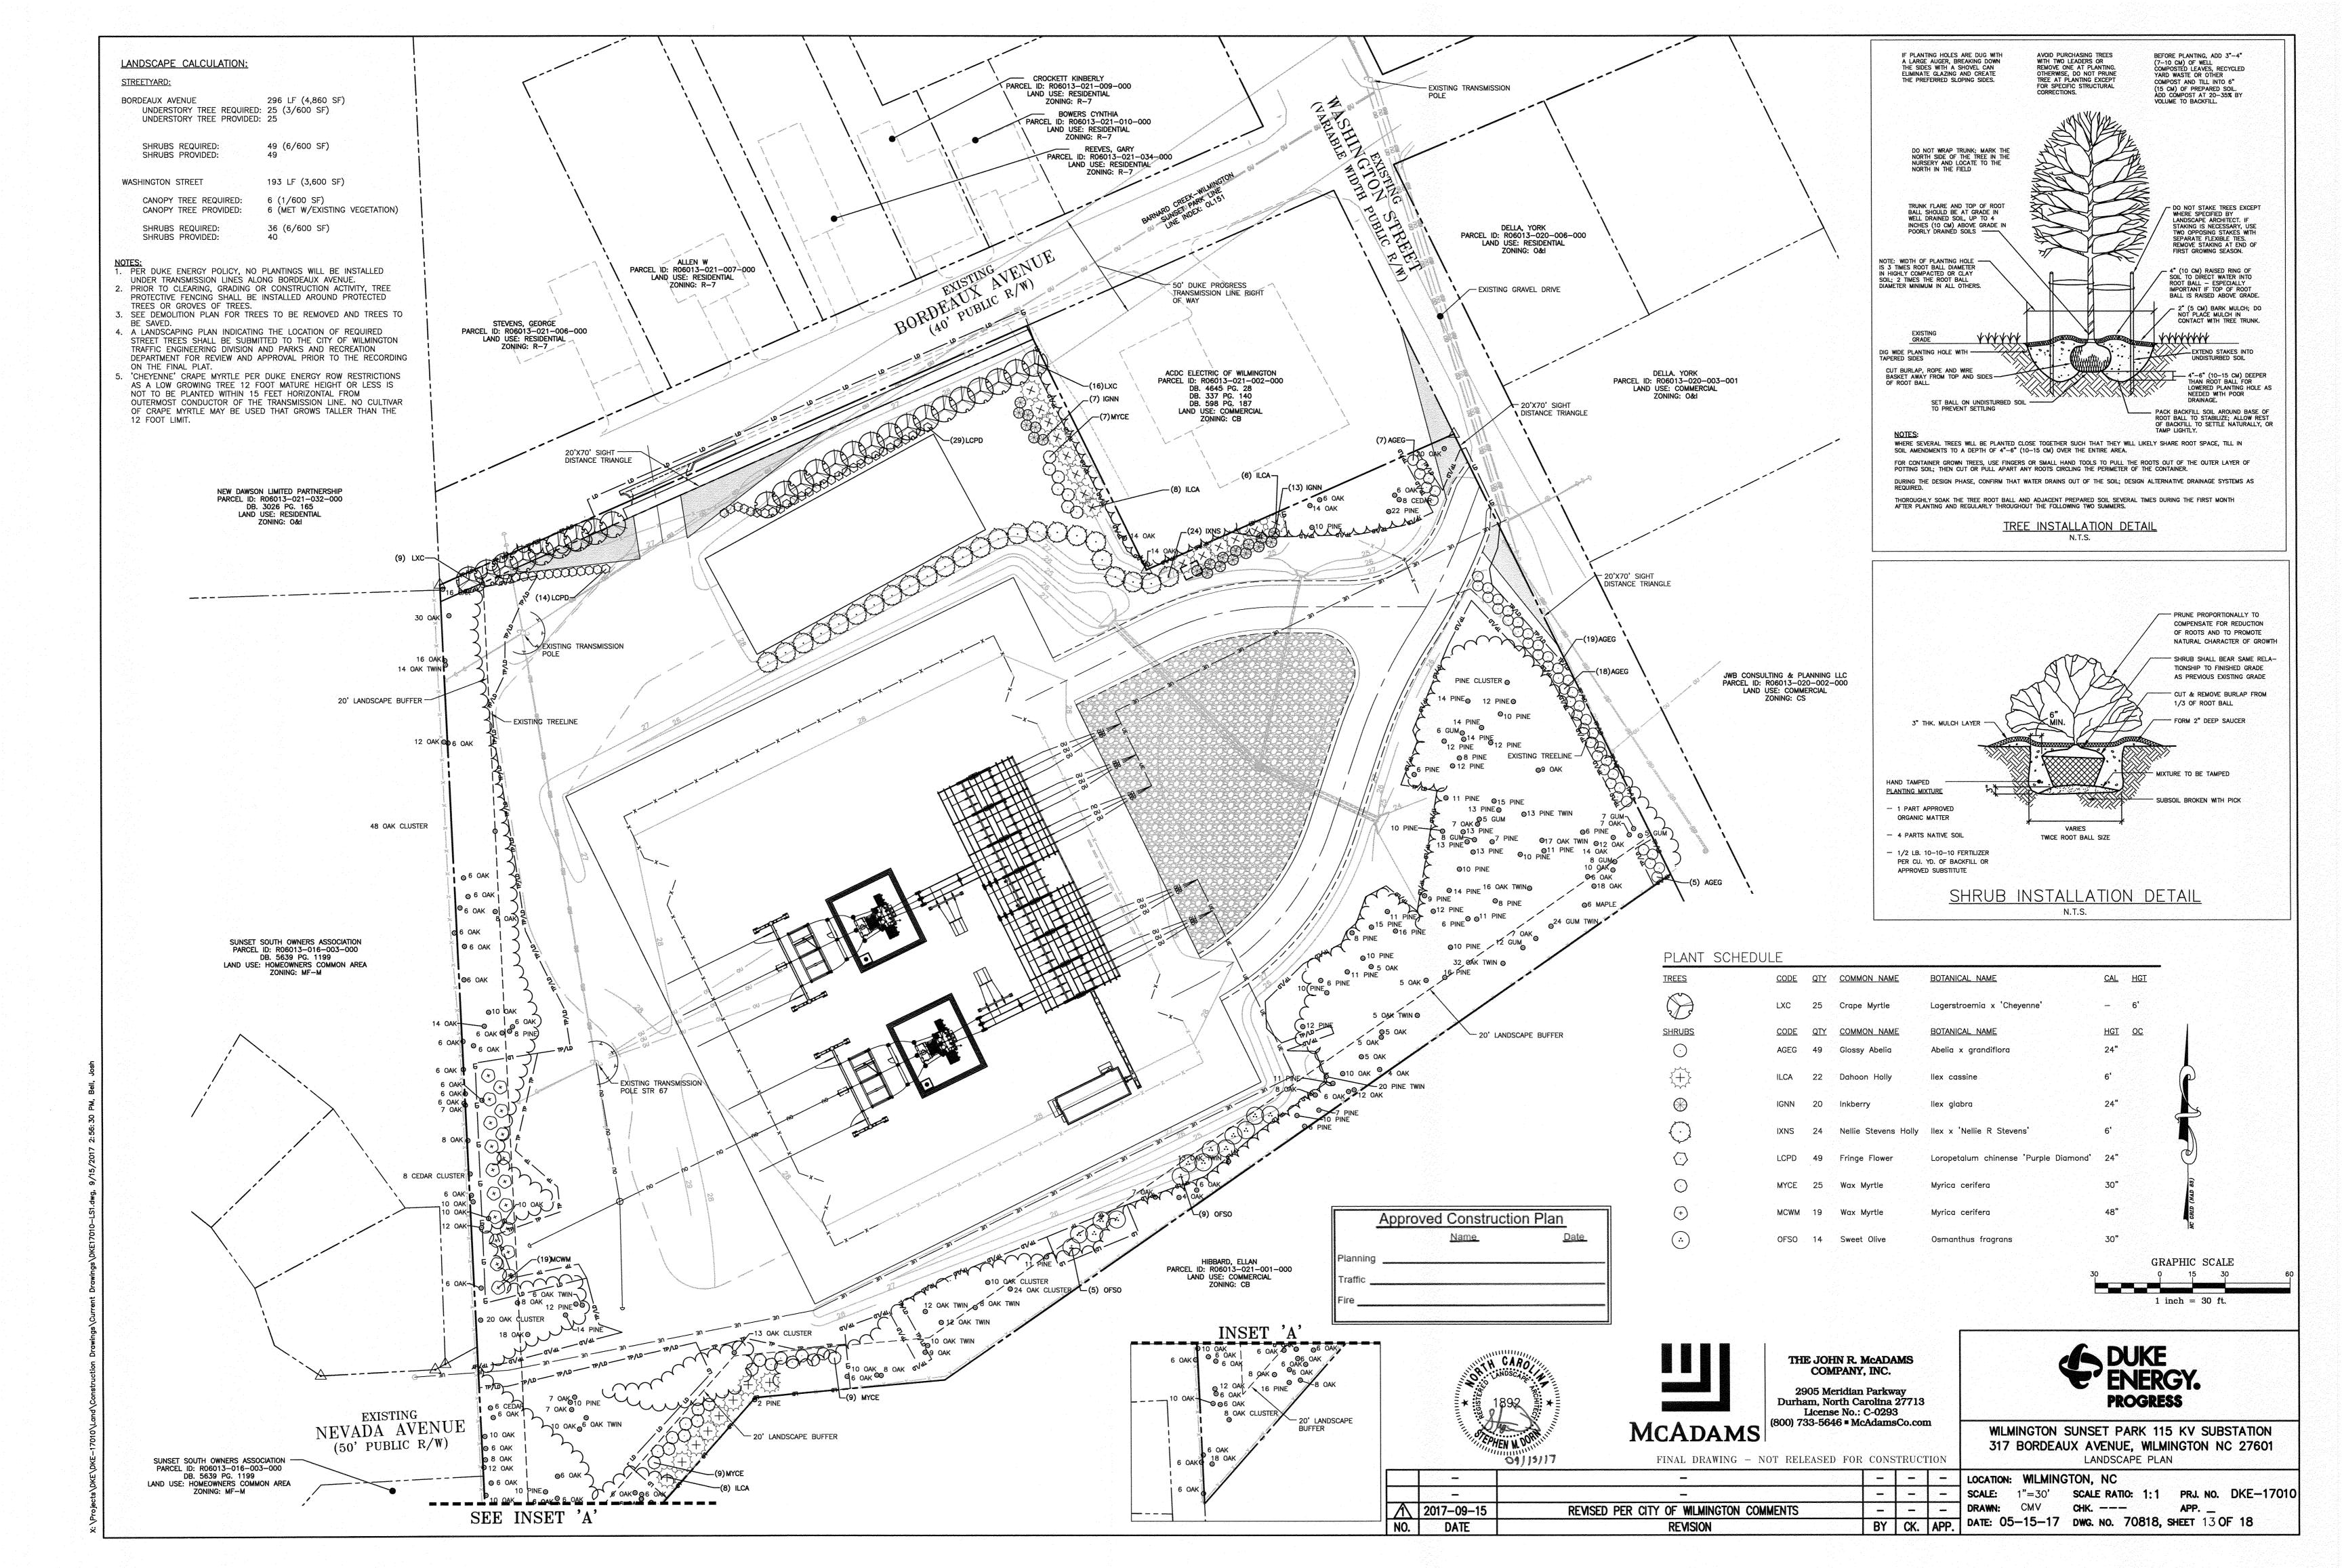

Aj	oproved (ed Construction Plan								
		Name_		Date						
Planning										
Traffic										
Fire										

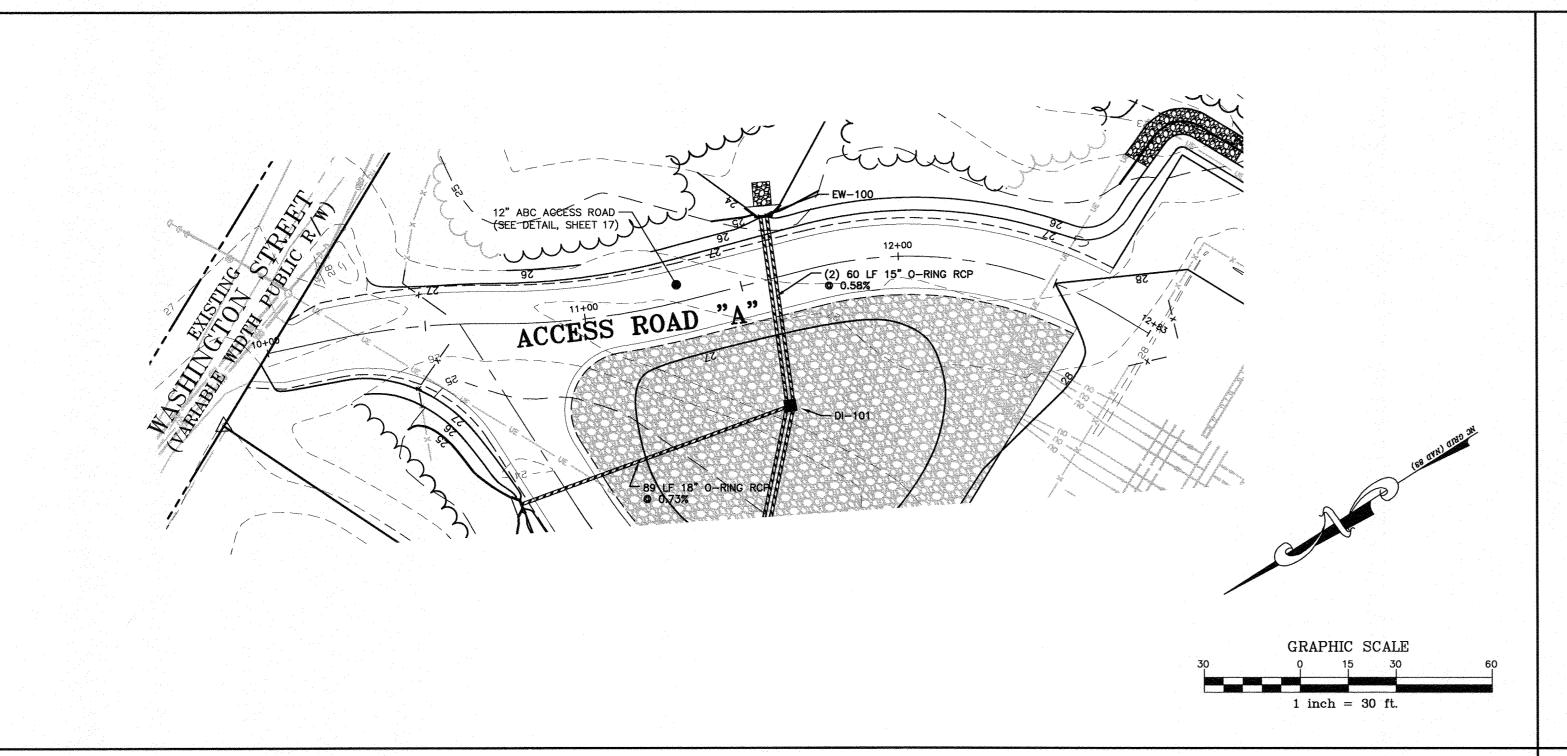ACCESS ROAD "B"

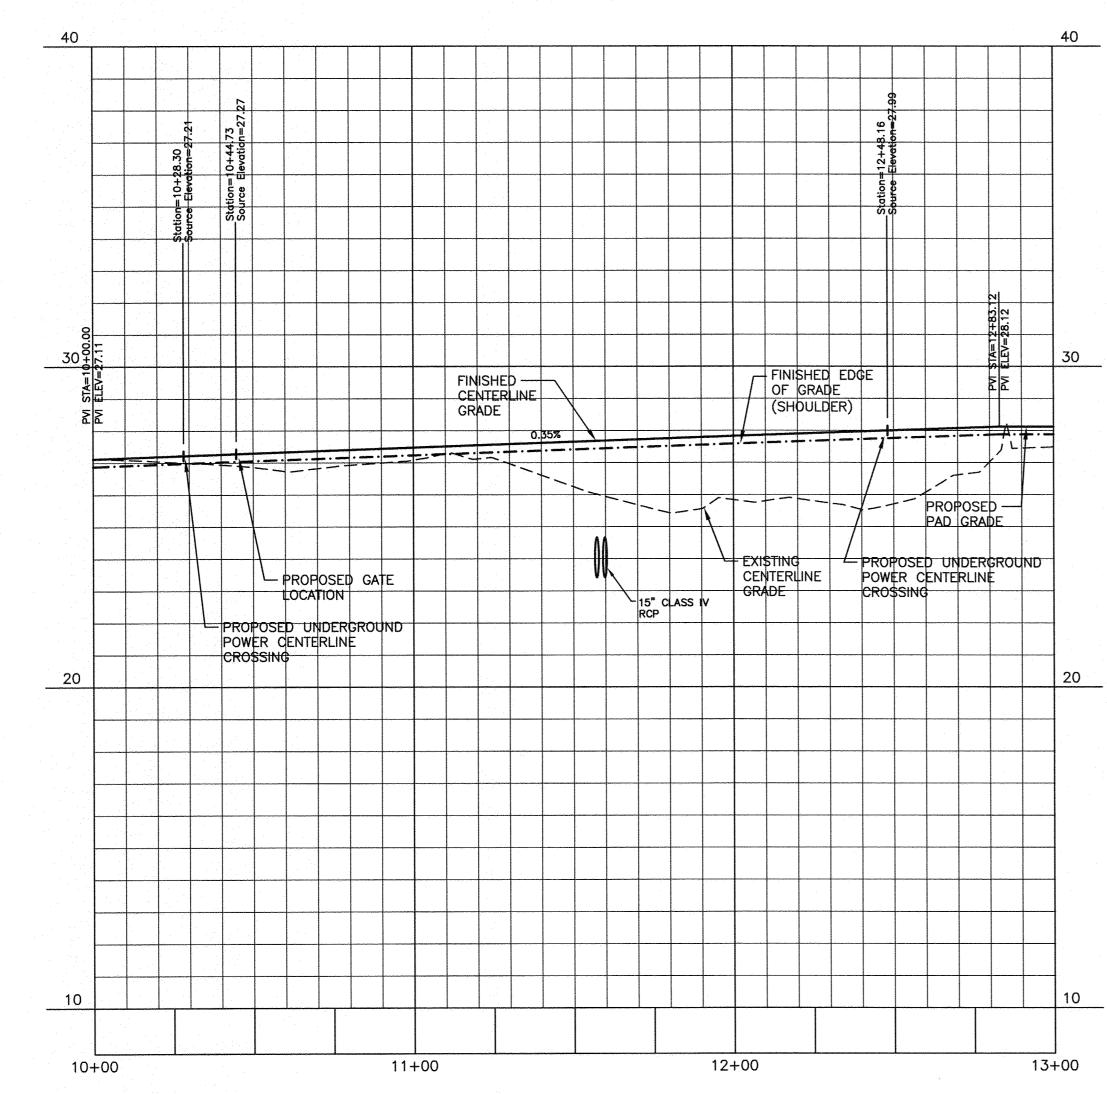



↑ 2017-09-15 NO. DATE




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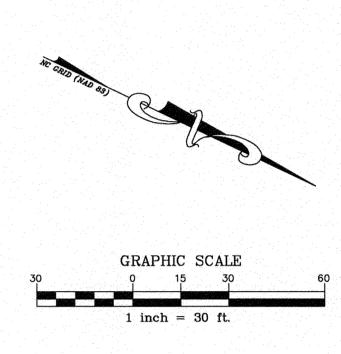
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DUKE ENERGY. PROGRESS


WILMINGTON SUNSET PARK 115 KV SUBSTATION 317 BORDEAUX AVENUE, WILMINGTON NC 27601 ACCESS ROAD PLAN & PROFILES

	-	=	-	LOCATION: WILMINGTON, NC
	-	-	-	SCALE: 1"=30'/1"=3' SCALE RATIO: 1:1 PRJ. NO. DKE-17010
REVISED PER CITY OF WILMINGTON COMMENTS	-	-	-	DRAWN: JB CHK APP
REVISION	BY	CK.	APP.	DATE: 05-15-17 DWG. NO. 70818, SHEET 14 OF 18



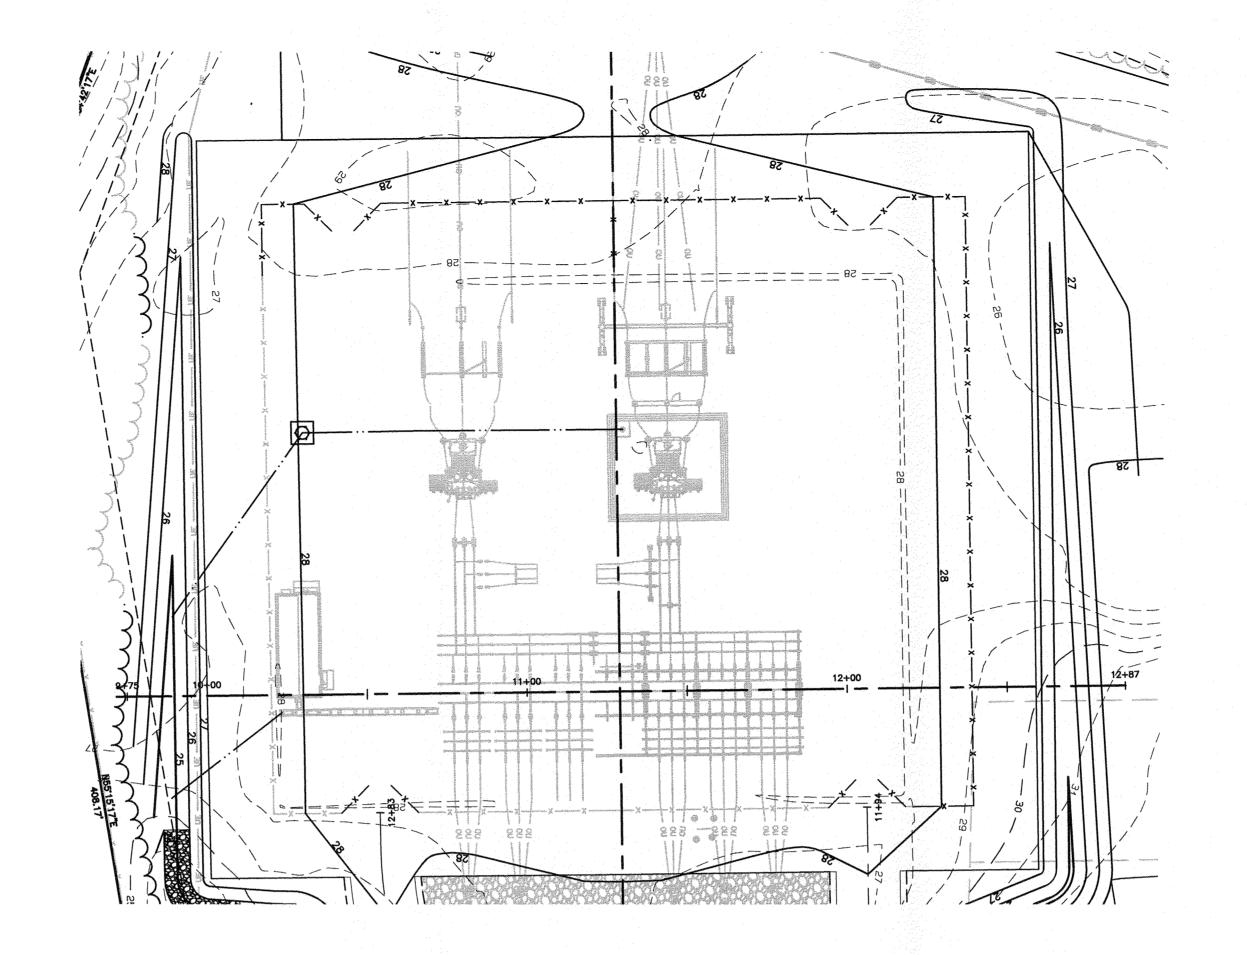

NORTH - SOUTH BASELINE

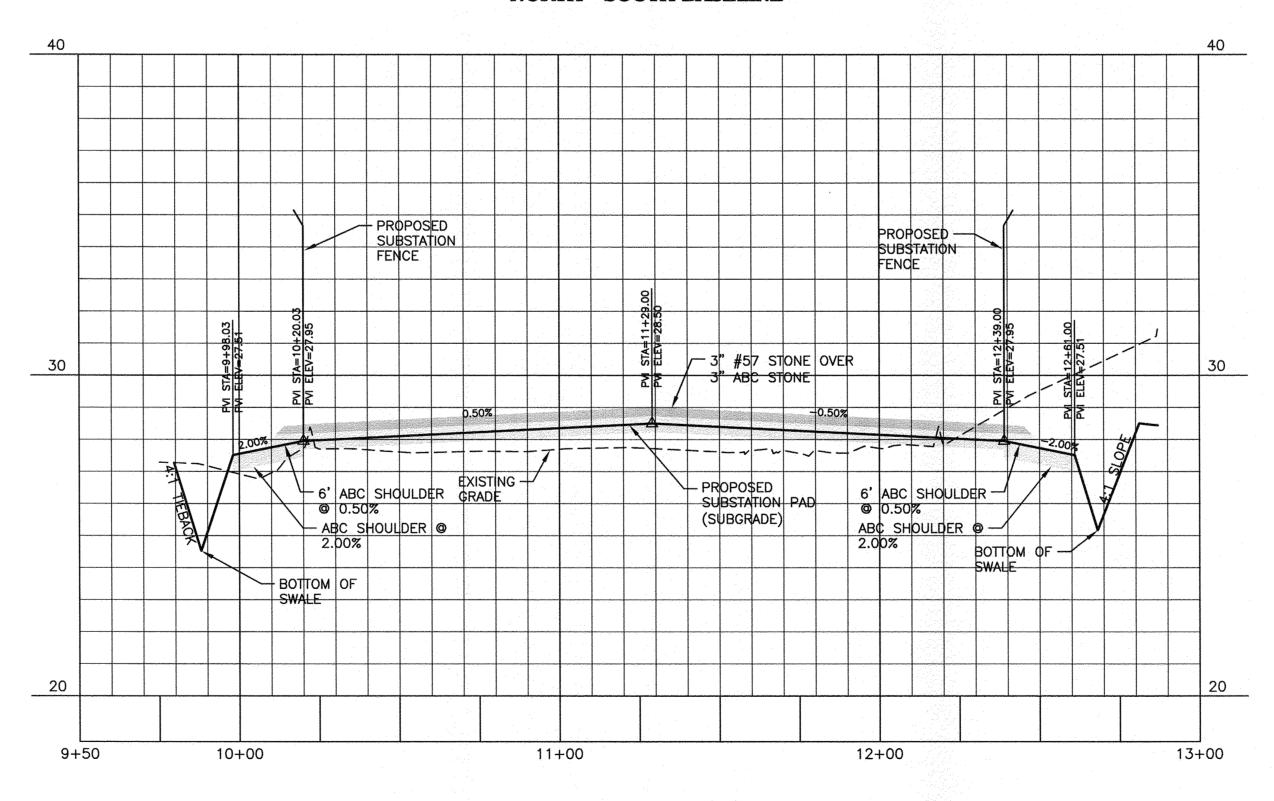





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DUKE ENERGY. PROGRESS

Approved Construction Plan


WILMINGTON SUNSET PARK 115 KV SUBSTATION 317 BORDEAUX AVENUE, WILMINGTON NC 27601 NORTH - SOUTH BASELINE PROFILE


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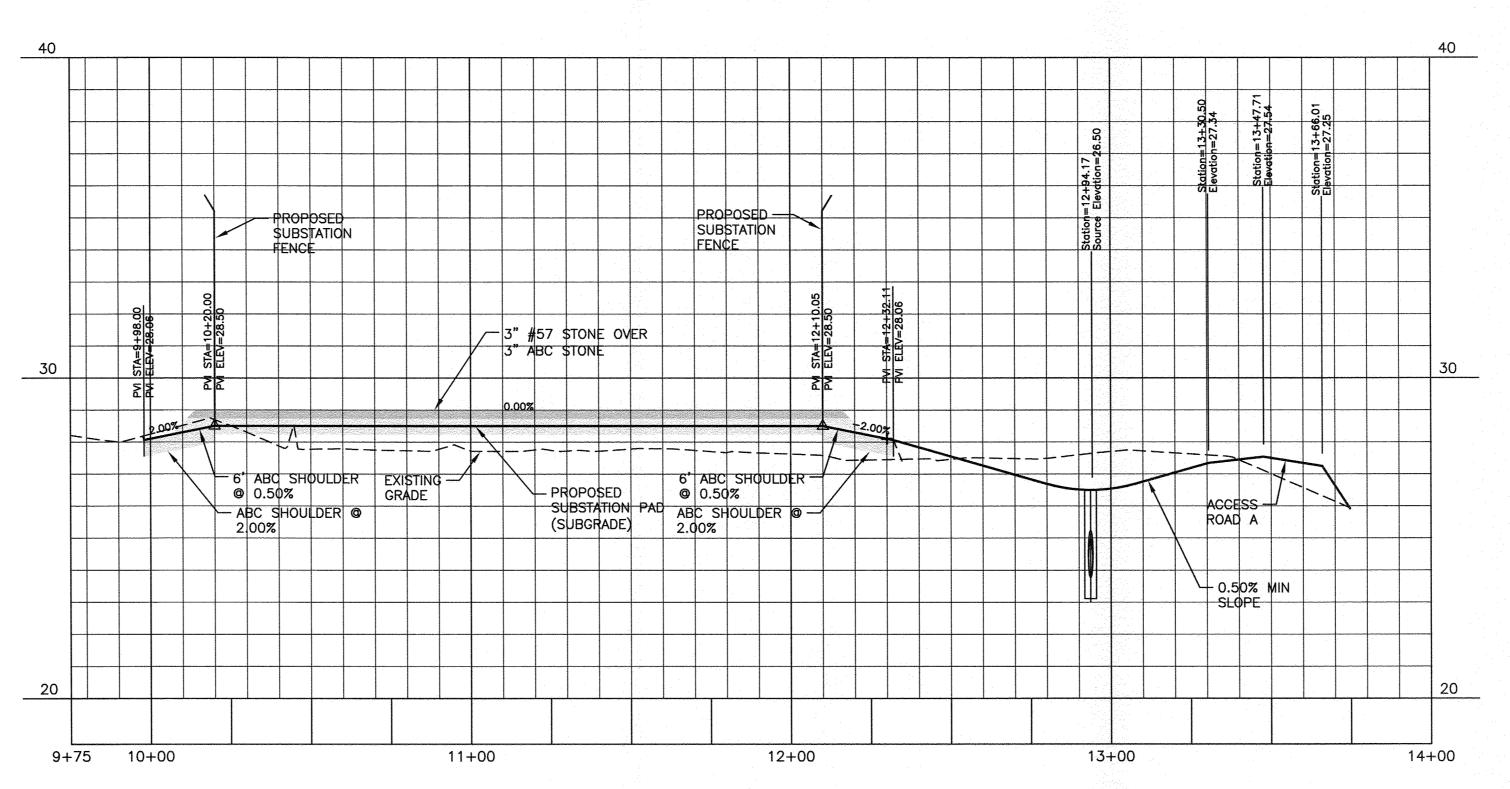
FINAL DRAWING - NOT RELEASED FOR CONSTRUCTION

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Λ	2017-09-15	REVISED PER CITY OF WILMINGTON COMMENTS			-	DRA
NO.	DATE	REVISION	BY	CK.	APP.	DATE



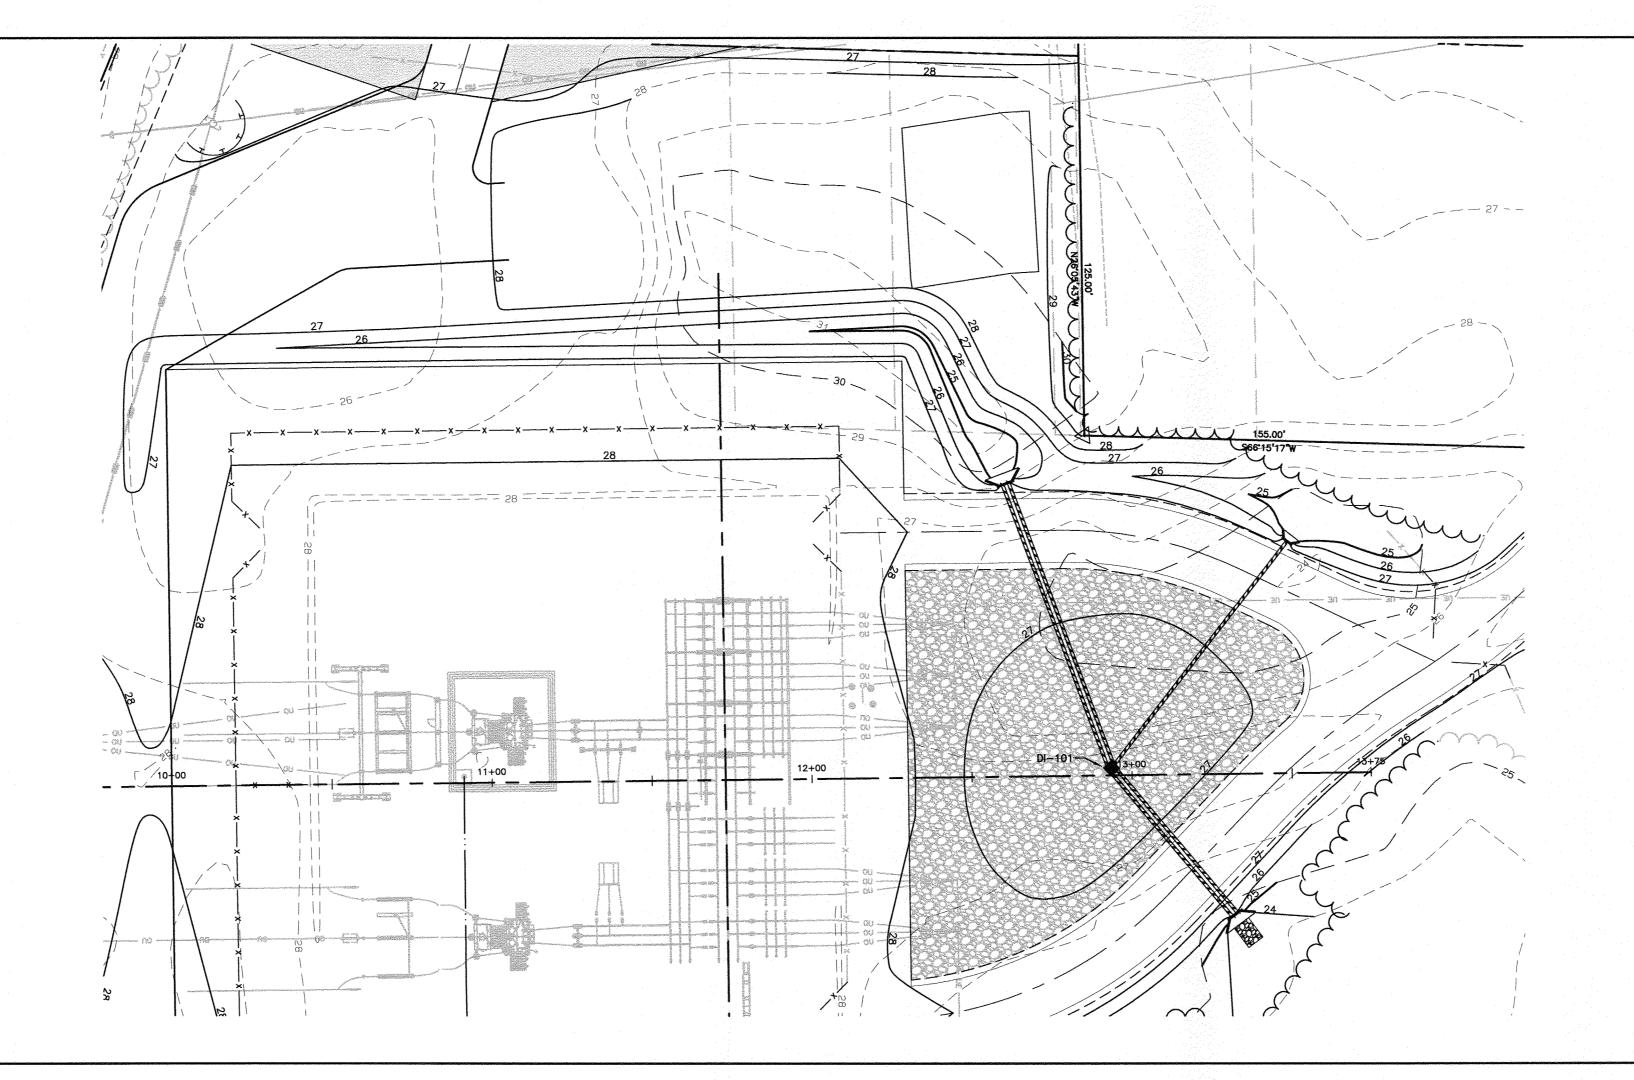

EAST - WEST BASELINE

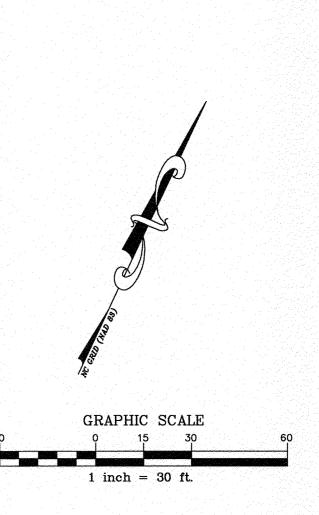






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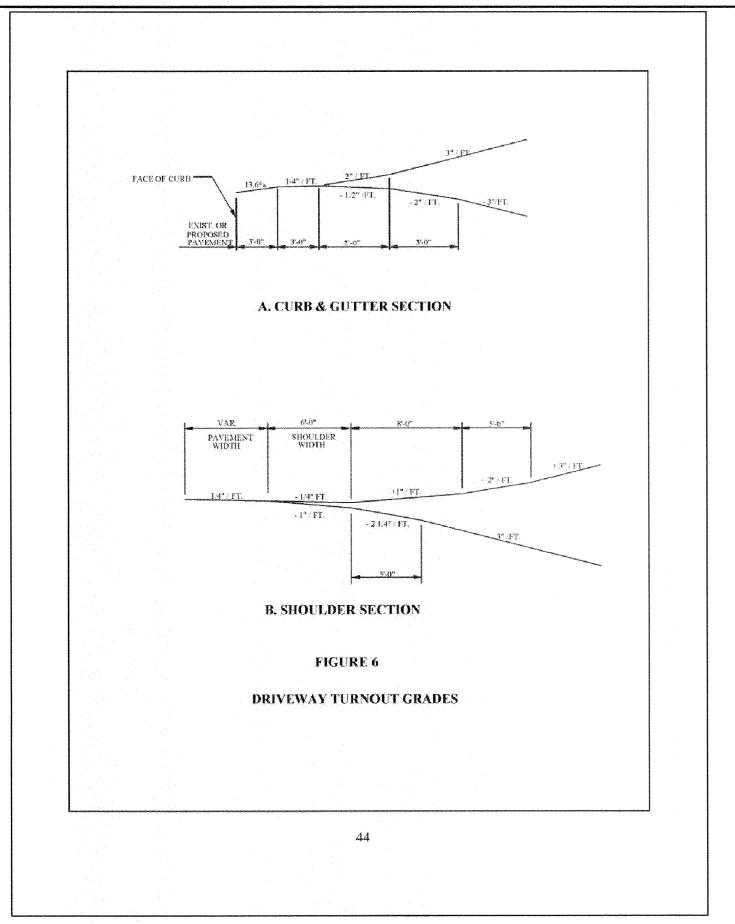
Approved Construction Plan <u>Date</u>





WILMINGTON SUNSET PARK 115 KV SUBSTATION 317 BORDEAUX AVENUE, WILMINGTON NC 27601

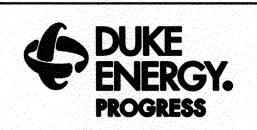
EAST — WEST BASELINE PROFILE


			FINAL DRAWING -	- NOT RELEASED FOR	CONS'	TRUC'	rion	EAST - WEST BASELINE PROFILE	
					-	-	4400	LOCATION: WILMINGTON, NC	
	-		_		-		-	SCALE: 1"=30'/1"=3' SCALE RATIO: 1:1 PRJ. NO. DKE-17010	
$\sqrt{}$	2017-09-15	RE	VISED PER CITY OF WILMINGTON (COMMENTS	-	-	-	DRAWN: JB CHK APP	
0.	DATE		REVISION		BY	CK.	APP.	DATE: 05-15-17 DWG. NO. 70818, SHEET 16 OF 18	




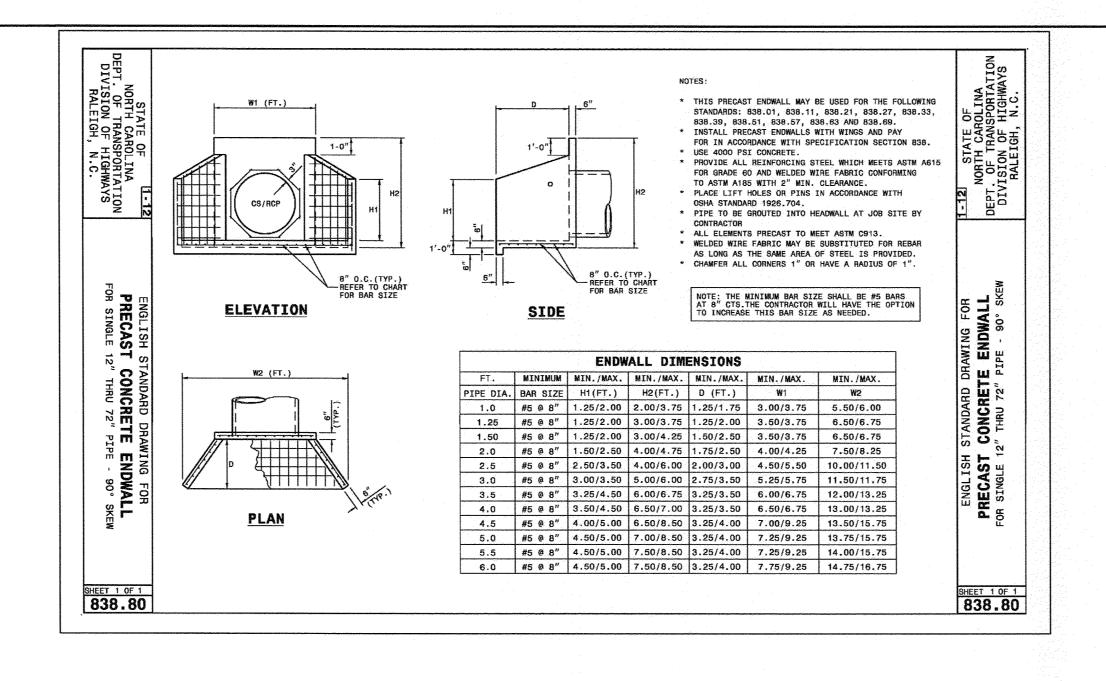


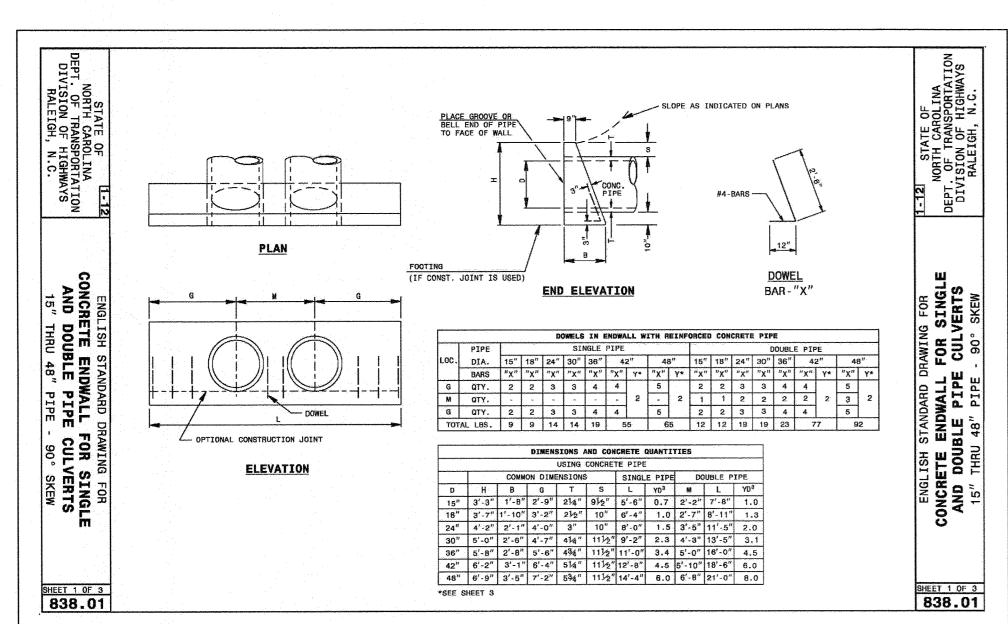


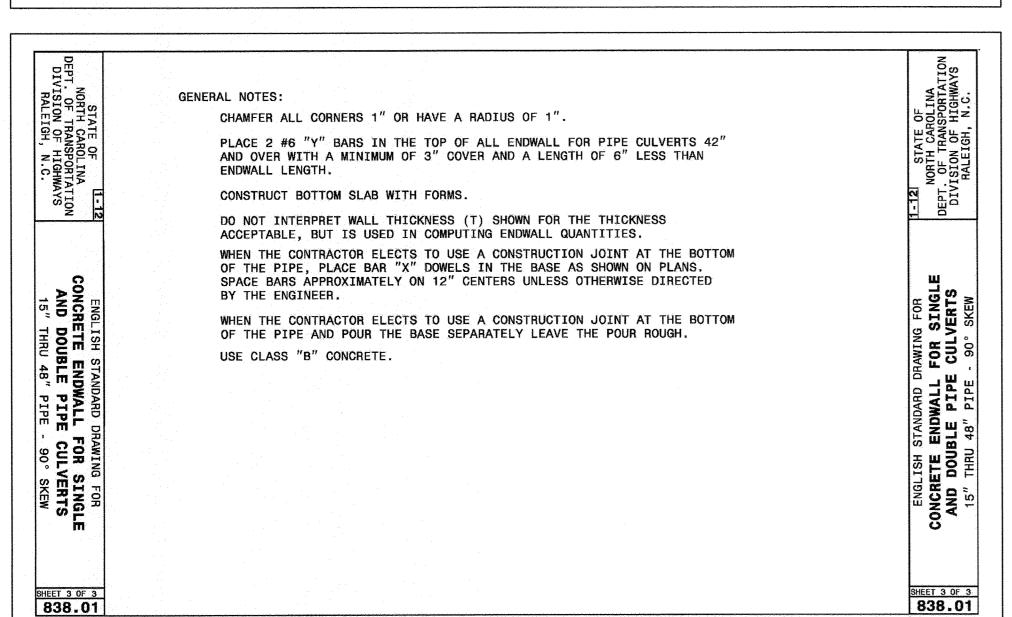


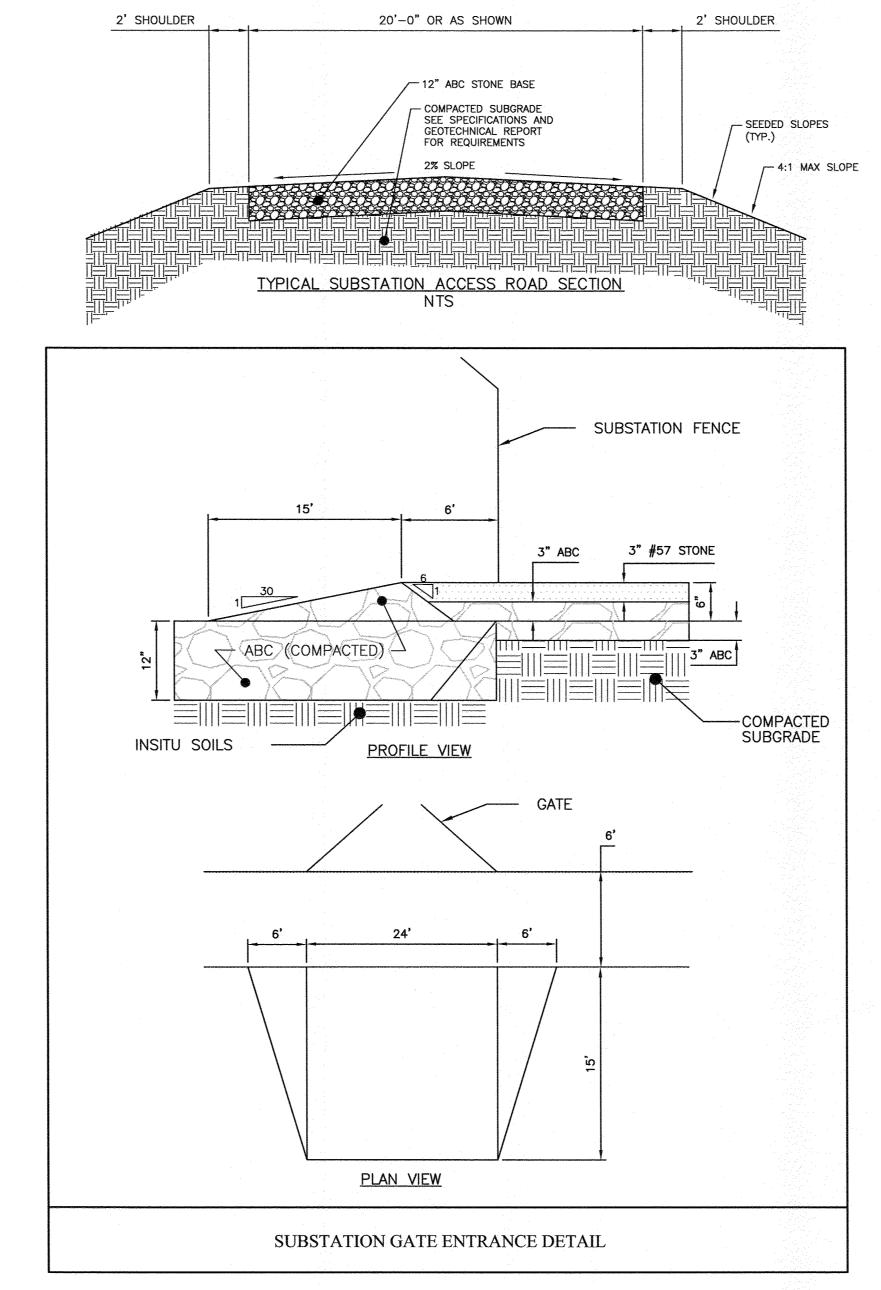

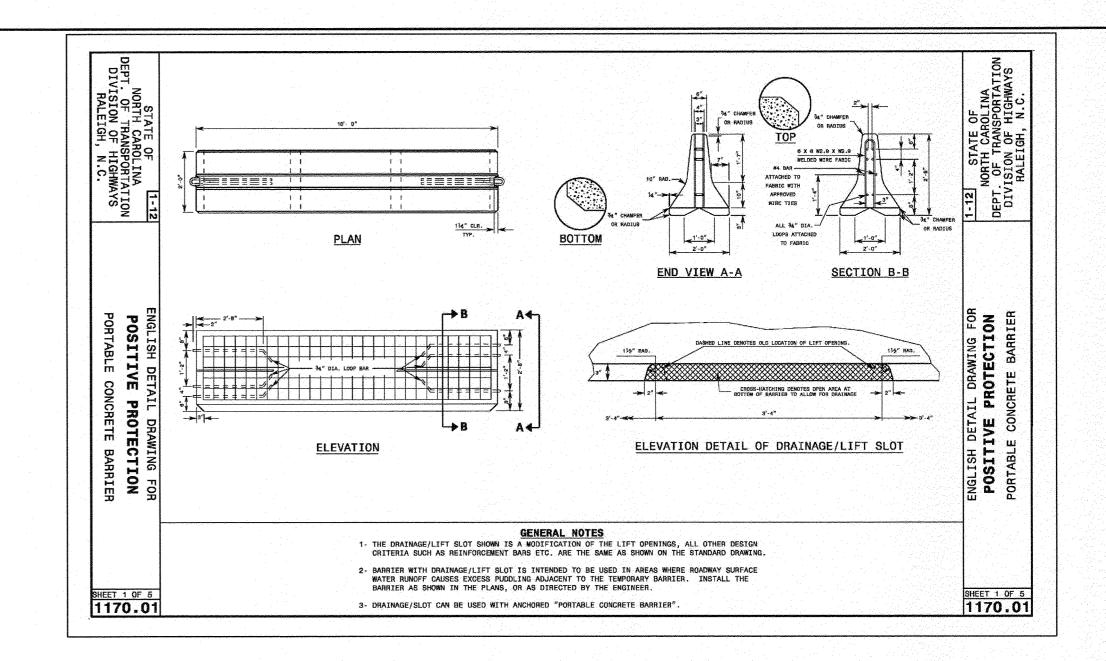

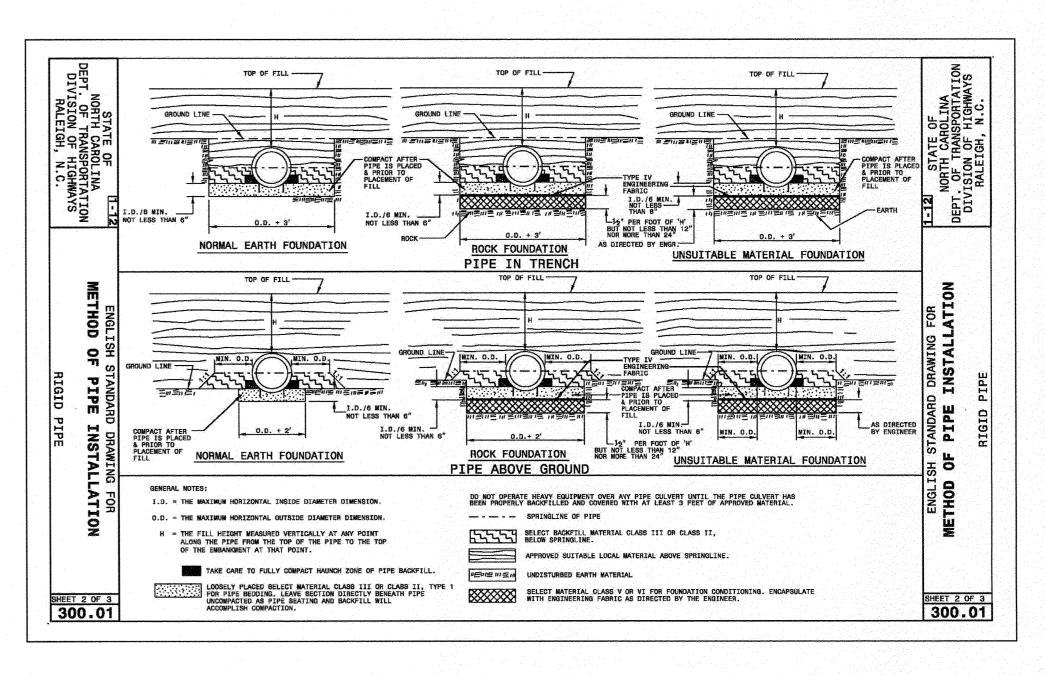

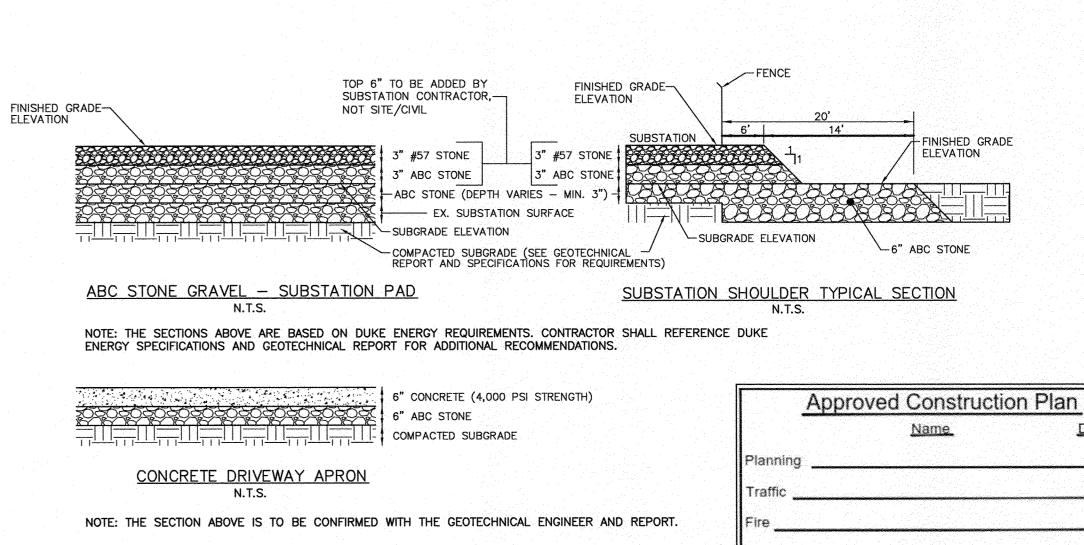

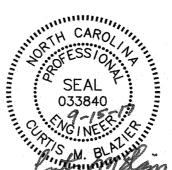



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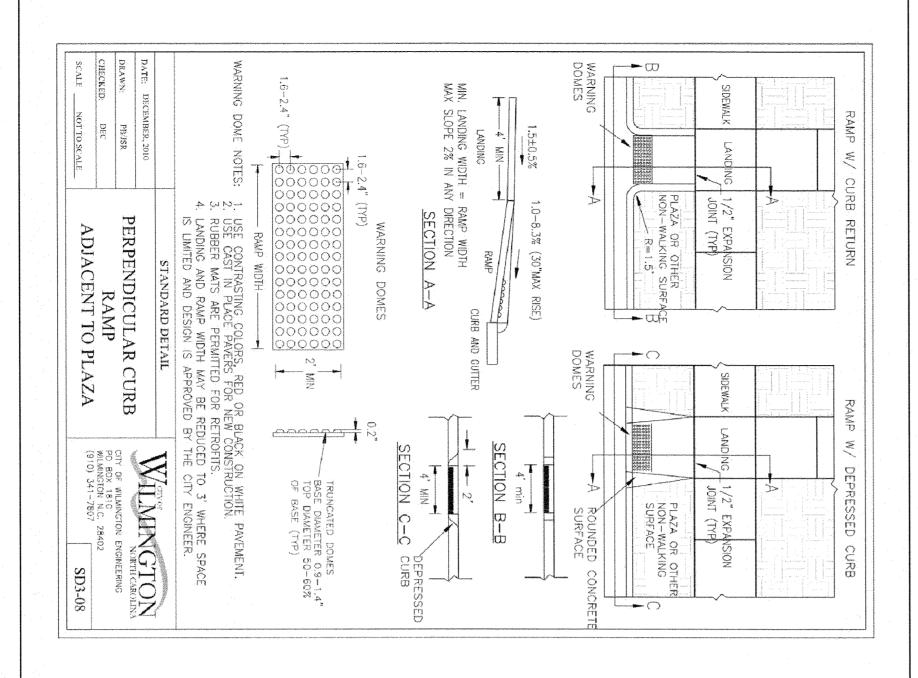
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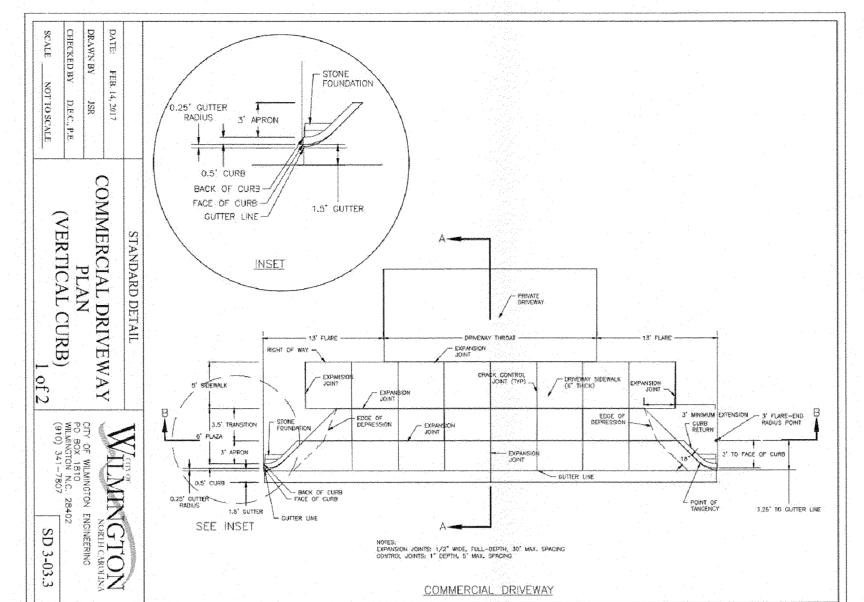
MCADAMS | (800) 733-5646 McAdamsCo.com | WLMINGTON 317 BORDE


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WILMINGTON SUNSET PARK 115 KV SUBSTATION 317 BORDEAUX AVENUE, WILMINGTON NC 27601 PROJECT DETAILS


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Λ	2017-09-15	REVISED PER CITY OF WILMINGTON COMMENTS		-	•	DRAWN: JB CHK APP
NO.	DATE	REVISION	BY	CK.	APP.	DATE: 05-15-17 DWG. NO. 70818, SHEET 17 OF 18





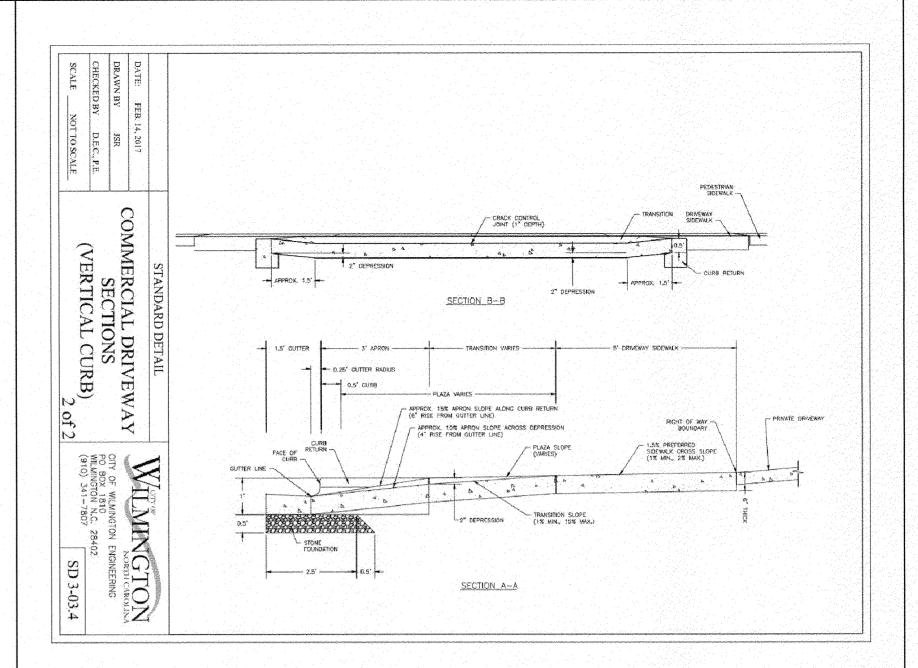

TREE CONSERVATION DATA

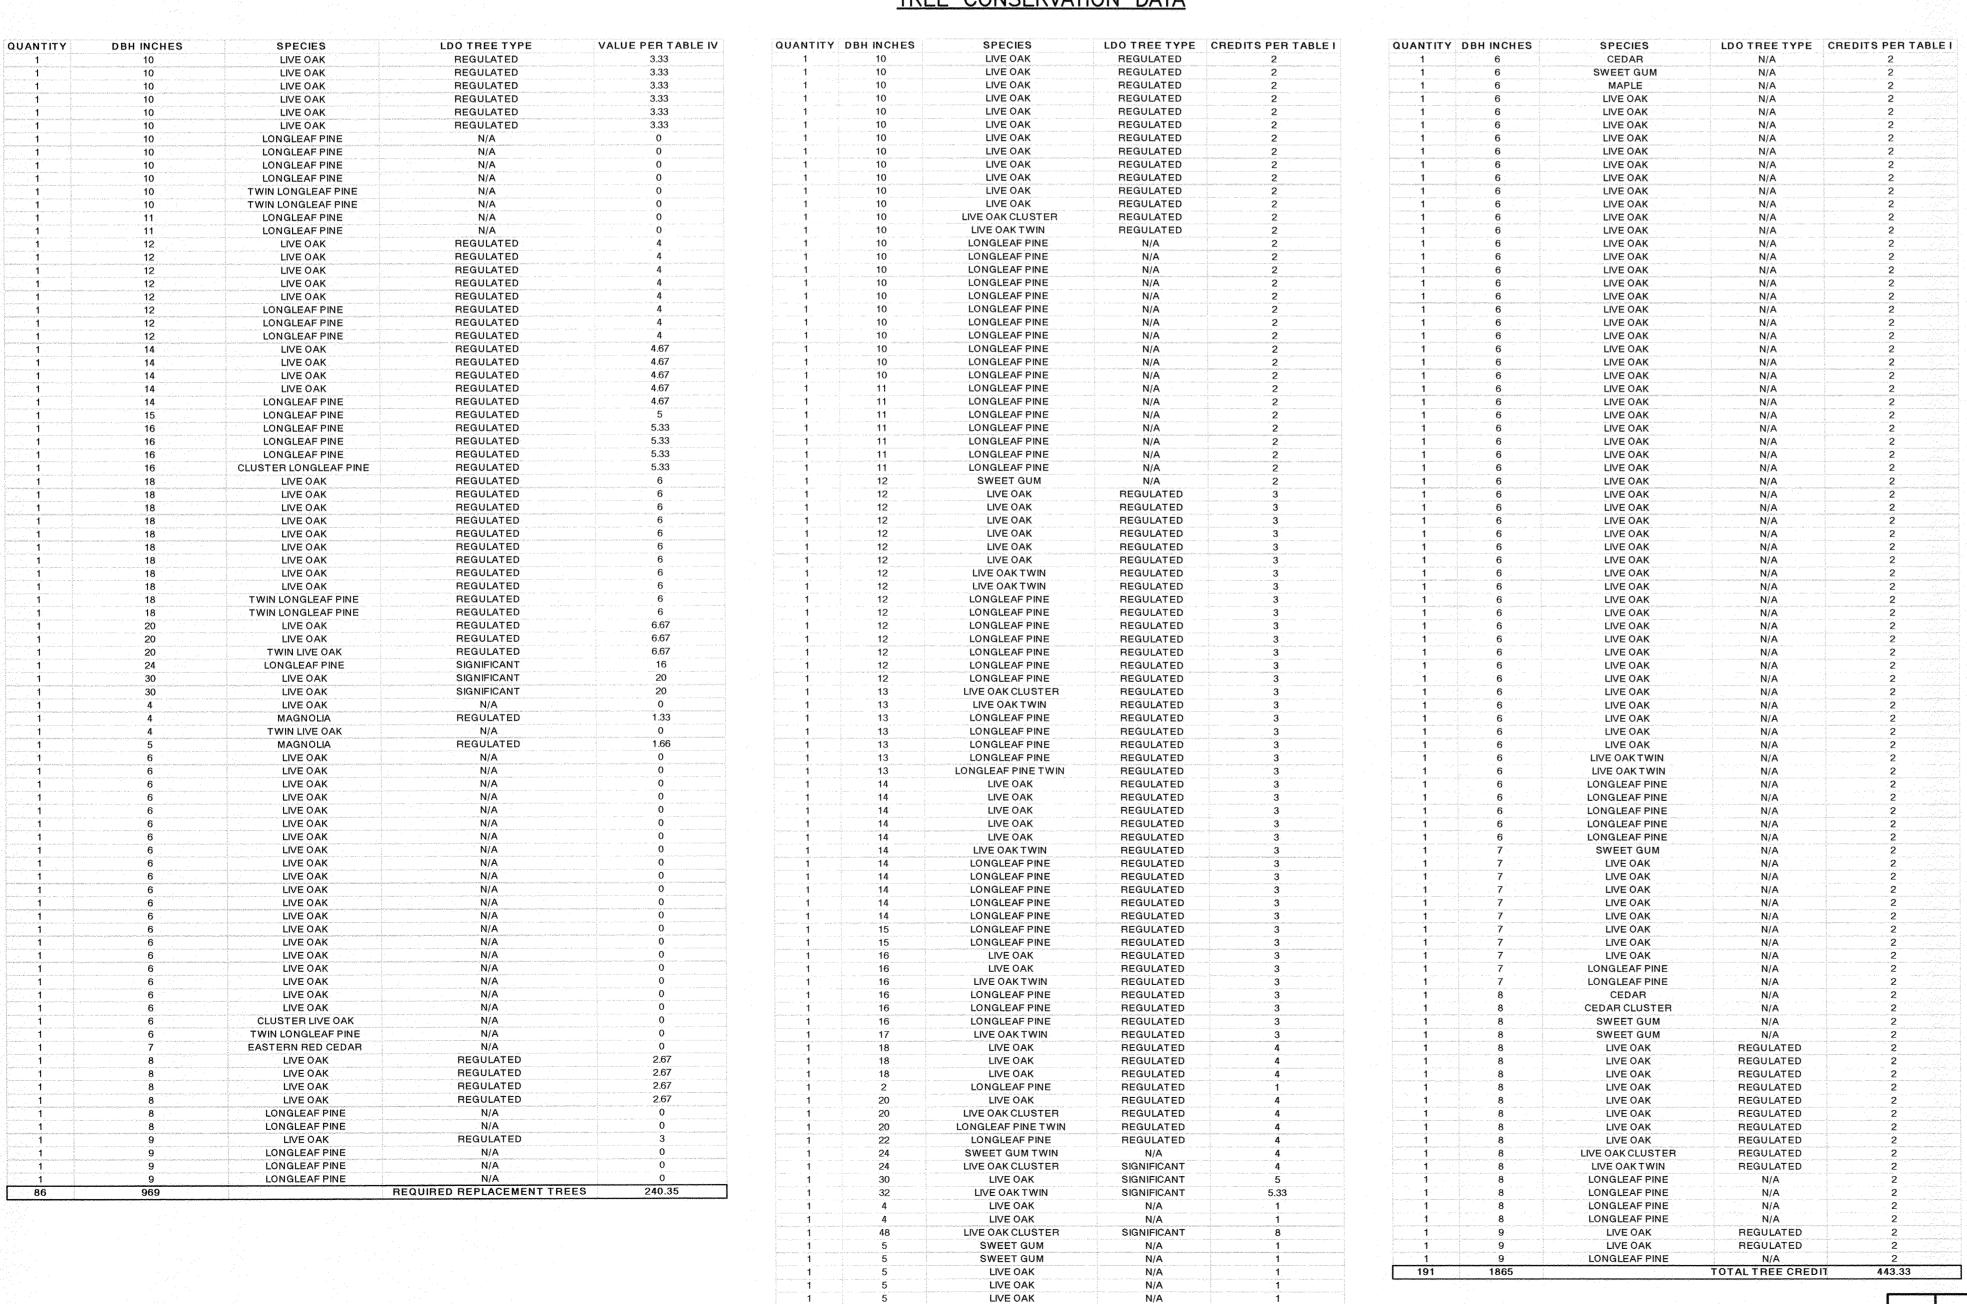


LIVE OAK


LIVE OAK TWIN CEDAR

LIVE OAK

N/A

N/A

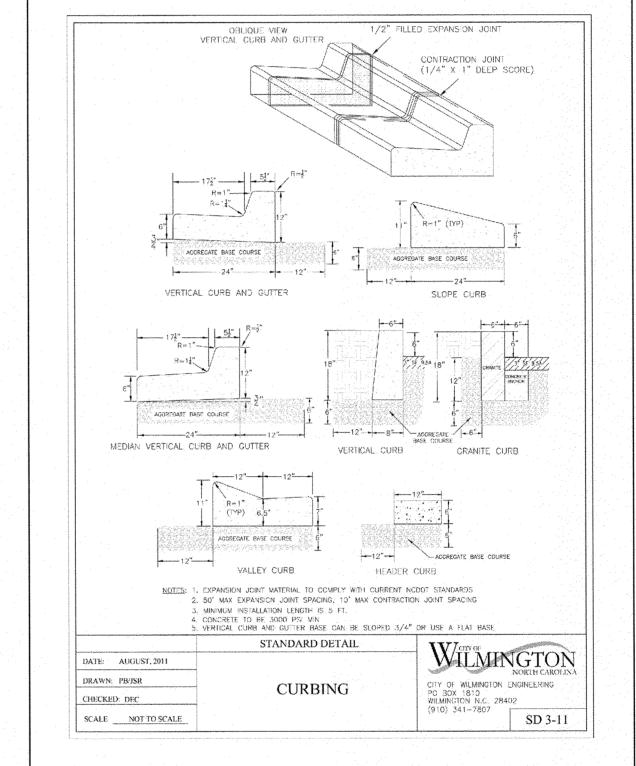

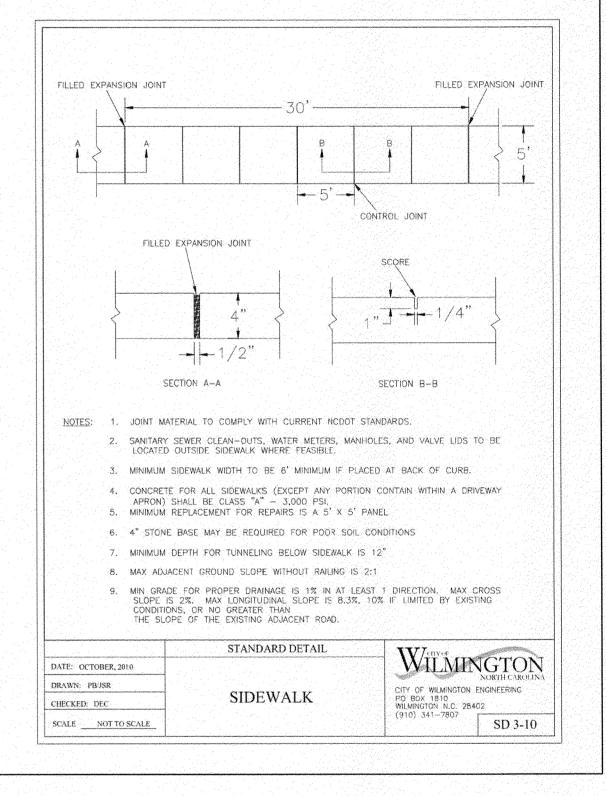



NO.



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Approved Construction Plan

<u>Date</u>

WILMINGTON SUNSET PARK 115 KV SUBSTATION 317 BORDEAUX AVENUE, WILMINGTON NC 27601 PROJECT DETAILS AND TREE CONSERVATION DATA

_		_
	LOCATION: WILMINGTON, NC	
	SCALE: NTS SCALE RATIO: 1:1 PRJ. NO. DKE-170	1
	DRAWN: JB CHK APP	
	DATE: 05-15-17 DWG. NO. 70818, SHEET 18 OF 18	



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17-09-15	RE	VISED PER	CITY OF WILMINGTON	COMMENTS		-	-	-	DRA
DATE			REVISION			BY	CK.	APP.	DAT